




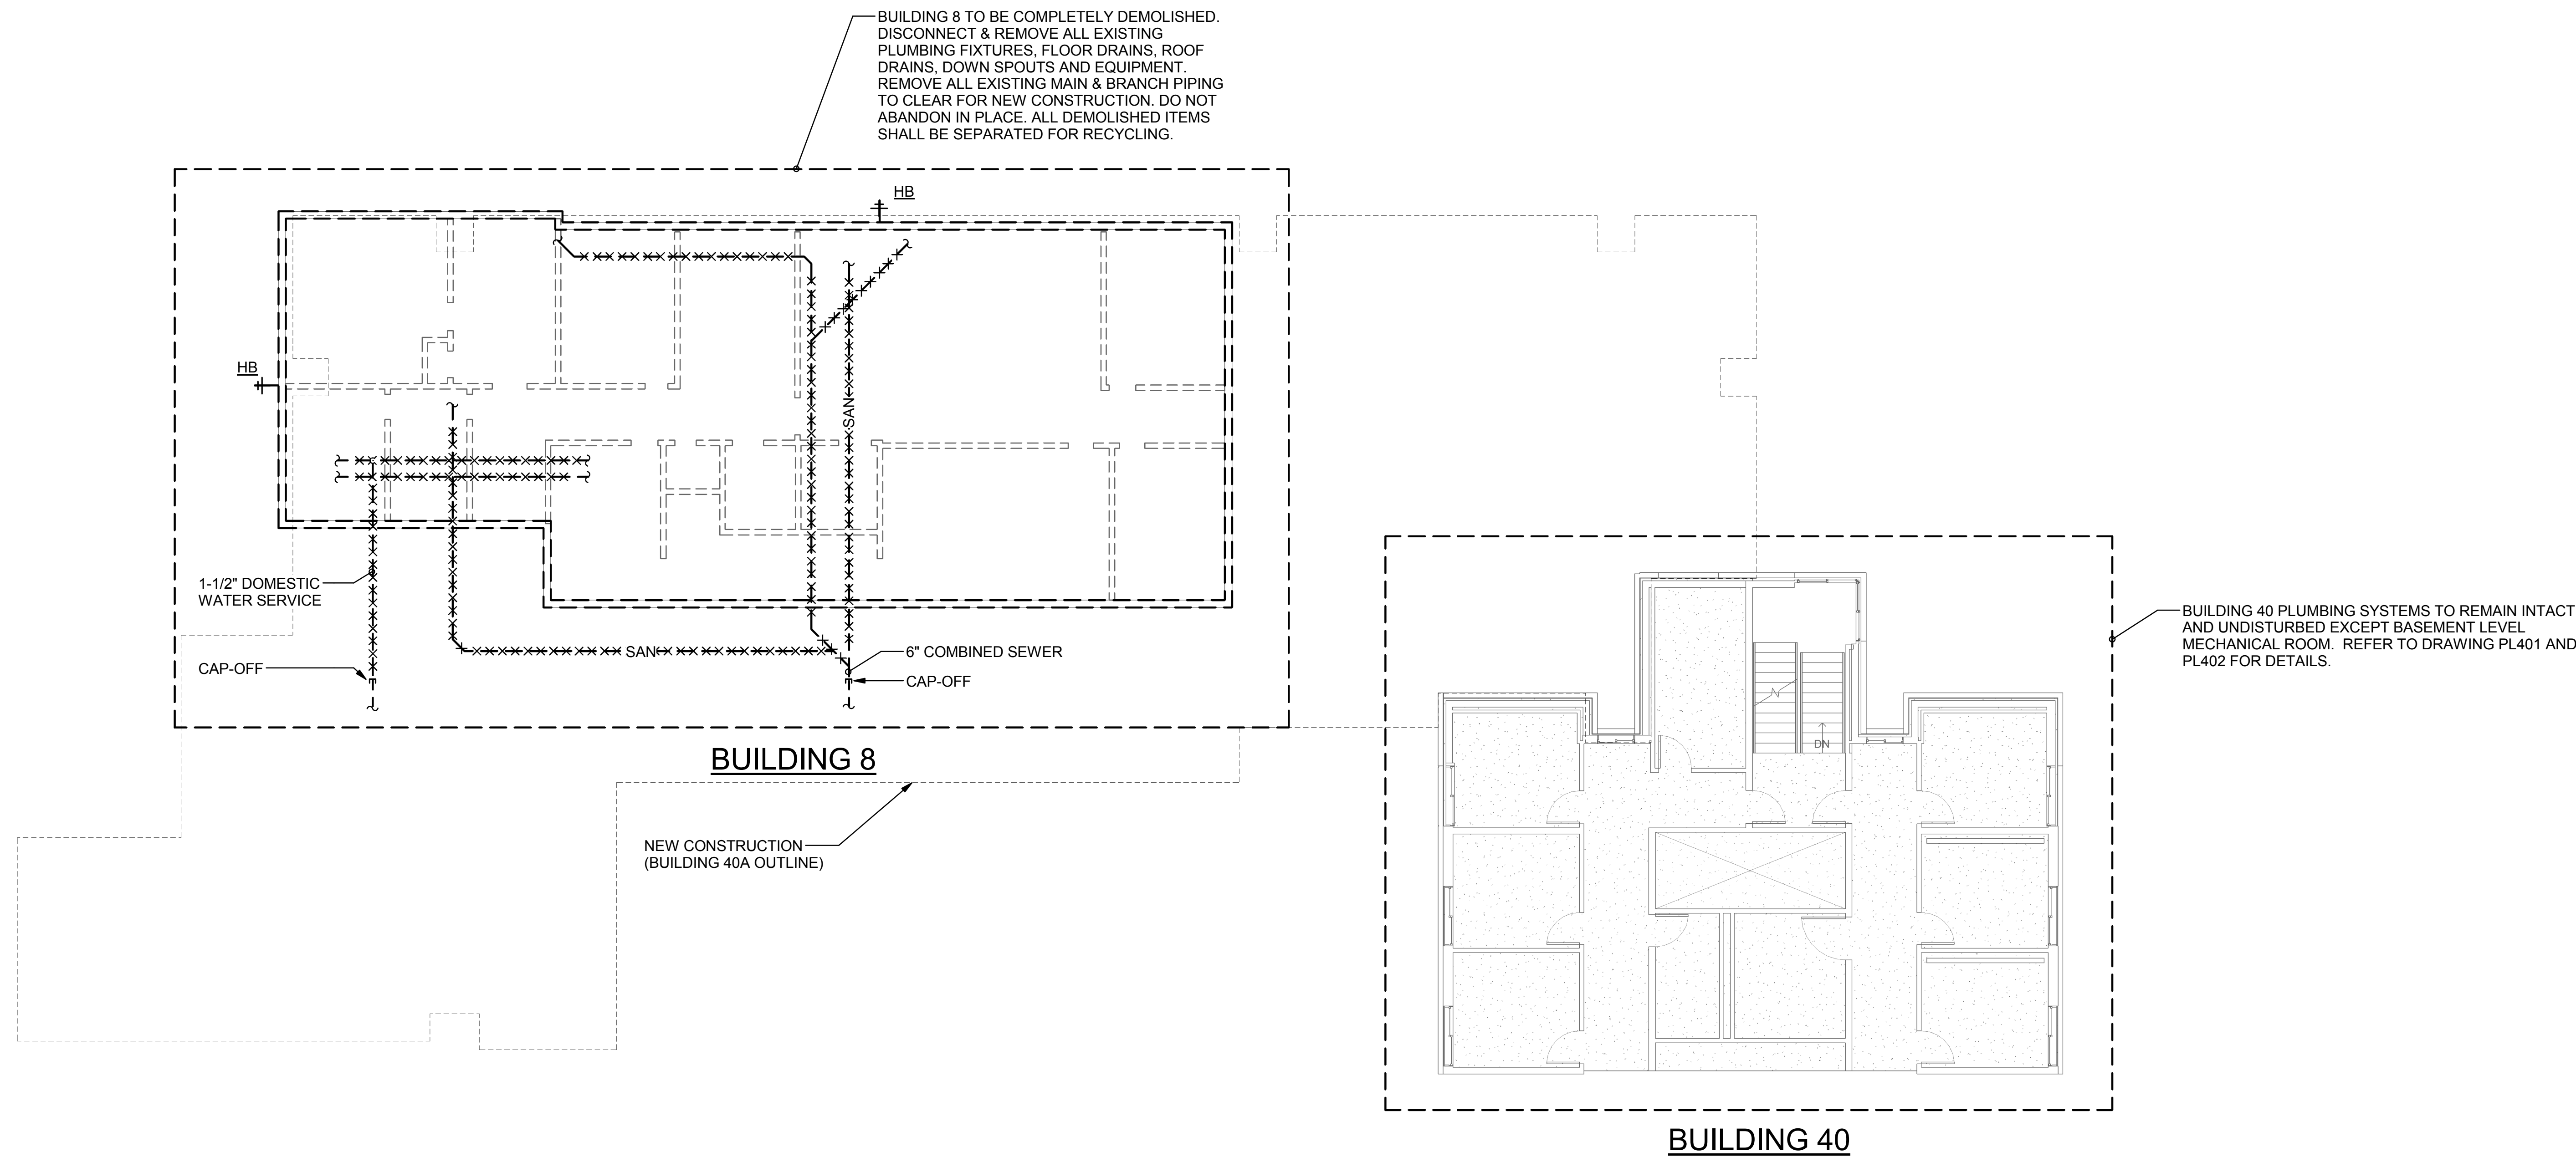
CONSULTANTS:	
<p>PROJECT 2013-0512 CONTACT John McMichael</p>  <p>INTERFACE ENGINEERING</p> <p>160 SW Main Street Suite 1600 Portland, OR 97204 TEL 503.382.2266 FAX 503.382.2262 www.interfaceengineering.com</p>	

 <p>EXP. 4/13/16 11/02/15</p>	<p>ARCHITECT/ENGINEERS:</p> <div style="display: flex; align-items: center;">  <div style="margin-left: 20px;"> <p>KMA ARCHITECTS</p> <p>14410 SE Petrovsky Rd, Suite 206 Renton, WA 98058 425-291-7078</p> </div> </div>	
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
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SPOKANE VA MEDICAL CENTER SPOKANE, WASHINGTON 99205			Building Number 40A	
Location SPOKANE, WASHINGTON 99205			Drawing Number PL001	
Issue Date 11/02/2015	Checked JRM	Drawn IEI	Dwg. of	

Office of
Construction
and Facilities
Management

 Department of
Veterans Affairs



BID DOCUMENT
NOVEMBER/02/2015



 Department of
Veterans Affairs

GENERAL SHEET NOTES

- A. SANITARY SEWER MAIN SHALL RUN @ 1%. BRANCH LINES SHALL BE RUN @ 2%.
- B. ALL FLOOR & OPEN SIZE DRAINS SHALL BE PRIMED.
- C. FLOOR DRAINS IN MECHANICAL ROOM SHALL HAVE DEEP SEAL TRAPS.

SHEET KEYNOTES

- 1 FLOOR DRAIN STRAINER SHALL BE SET @ 1" BELOW FINISHED FLOOR ELEVATION. COORDINATION SLOPING OF CONCRETE WITH DIVISION 3 WORK.
- 2 VERIFY EXACT LOCATION OF EXISTING 6" SANITARY SEWER LATERAL FROM BLDG 40A. REMOVE EXISTING PIPING TO CLEAR FOR NEW CONSTRUCTION. DO NOT ABANDON IN PLACE. COORDINATE WITH CIVIL WORK TO PROVIDE TEMPORARY CONNECTION OF SANITARY SEWER DURING CONTRUCTION OF BUILDING 40A.
- 3 COORDINATE RE-ROUTING OF BUILDING 40E SANITARY SEWER WITH COR & FACILITIES MANAGER.

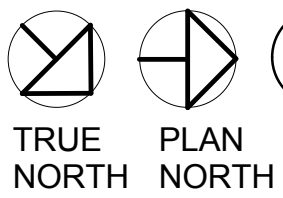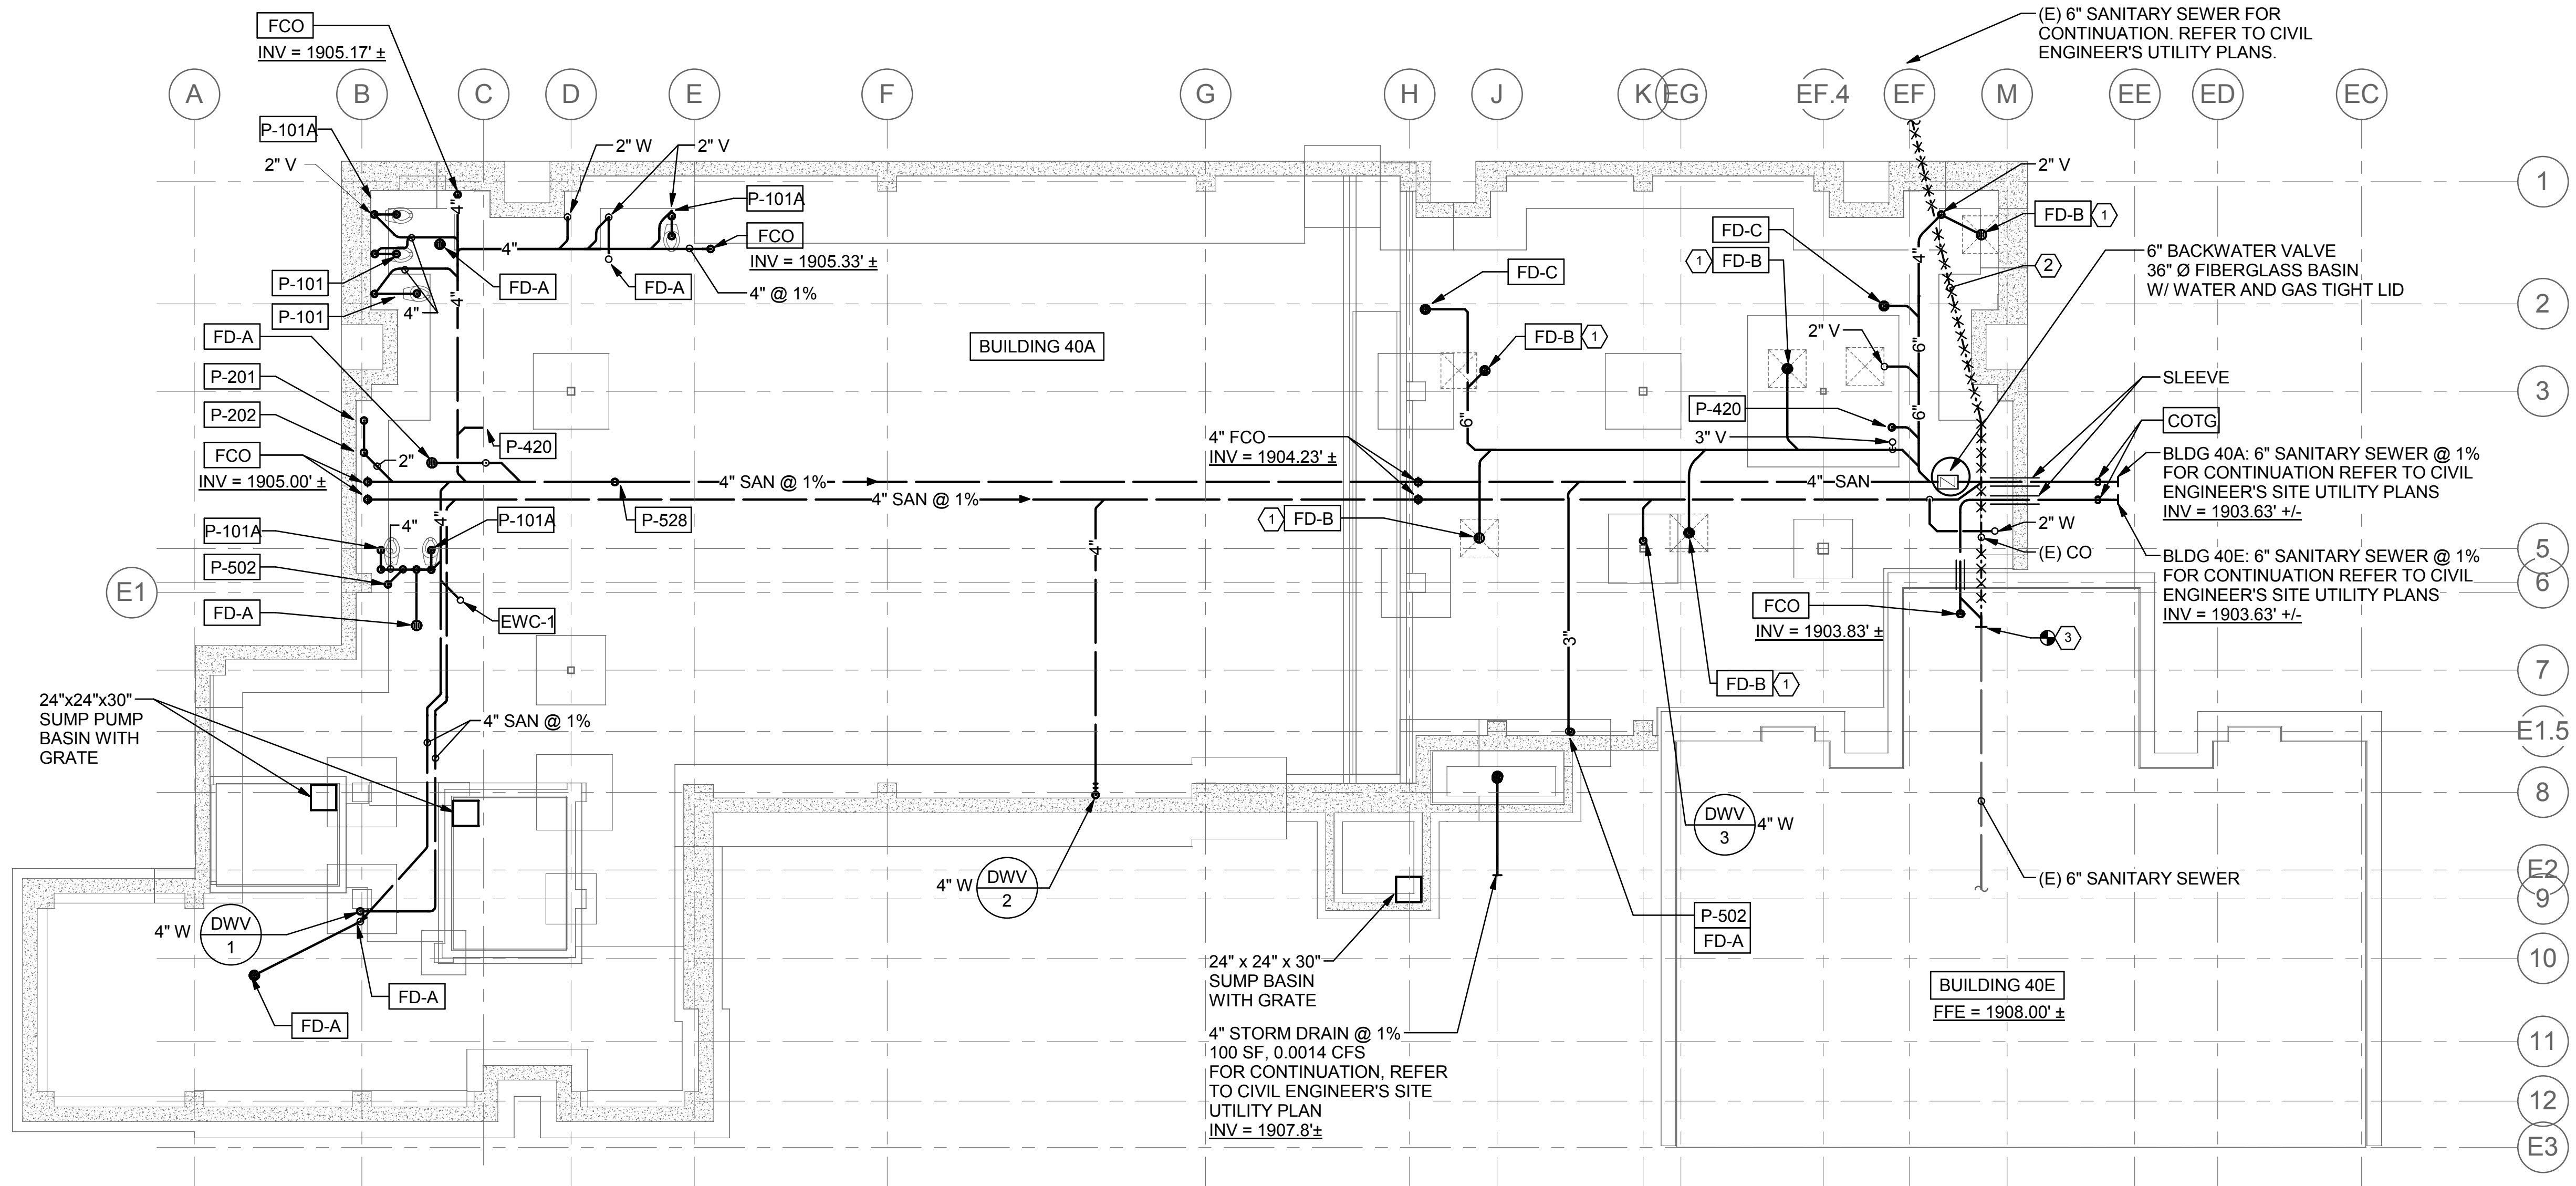

1 BELOW GRADE PLUMBING PLAN

1/8" = 1'-0"


FFE = 1907' - 4"

BID DOCUMENT
NOVEMBER/02/2015

	BID DOCUMENT	11/02/2015
	100% CONSTRUCTION DOCUMENT	1/26/2015
	99% CONSTRUCTION DOCUMENT	12/30/14
	95% CONSTRUCTION DOCUMENT	12/17/14
	65% DESIGN DEVELOPMENT	10/13/14
	SCHEMATIC DESIGN	6/27/14
		3/28/14
Revisions	ISSUES	Date

CONSULTANTS:

PROJECT: 2013-0512
CONTACT: John McMichael
INTERFACE
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100 SW Main Street
Suite 1600
Portland, OR 97204
TEL: 503.382.2266
FAX: 503.382.2262
www.interfaceengineering.com

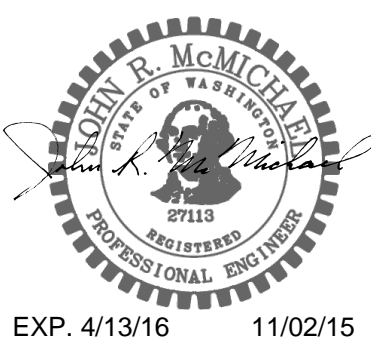

ARCHITECT/ENGINEERS:

KMA
ARCHITECTS
14410 SE Petrovitsky Rd, Suite 206
Renton, WA 98058
425-291-7078

Drawing Title
BELOW GRADE PLUMBING PLAN

Approved: Project Director
Approver


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INTENSIVE OUTPATIENT MENTAL HEALTH AND EDUCATION BUILDING
SPOKANE VA MEDICAL CENTER
SPOKANE, WASHINGTON 99205

Location
SPOKANE, WASHINGTON 99205
Issue Date
11/02/2015

Project Number
668-313
Building Number
40A

Drawing Number
PL099
Dwg. of



Office of
Construction
and Facilities
Management

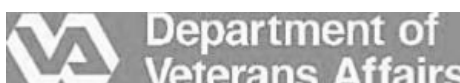

DEDUCTIVE ALTERNATE BID AREA #1
CONSTRUCTION NOTES:

1. DELETE ALL PLUMBING FIXTURES AND DRAINS FROM SCOPE OF WORK EXCEPT P-801 WALL HYDRANTS. PROVIDE ALL WATER AND WASTE PIPING SERVING FLOORS ABOVE.
2. ROUGH-IN ONLY, FOR ALL PLUMBING FIXTURES AND DRAINS SHOWN IN ALTERNATE BID AREA #1.

DEDUCTIVE ALTERNATE BID AREA #1

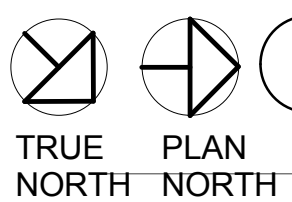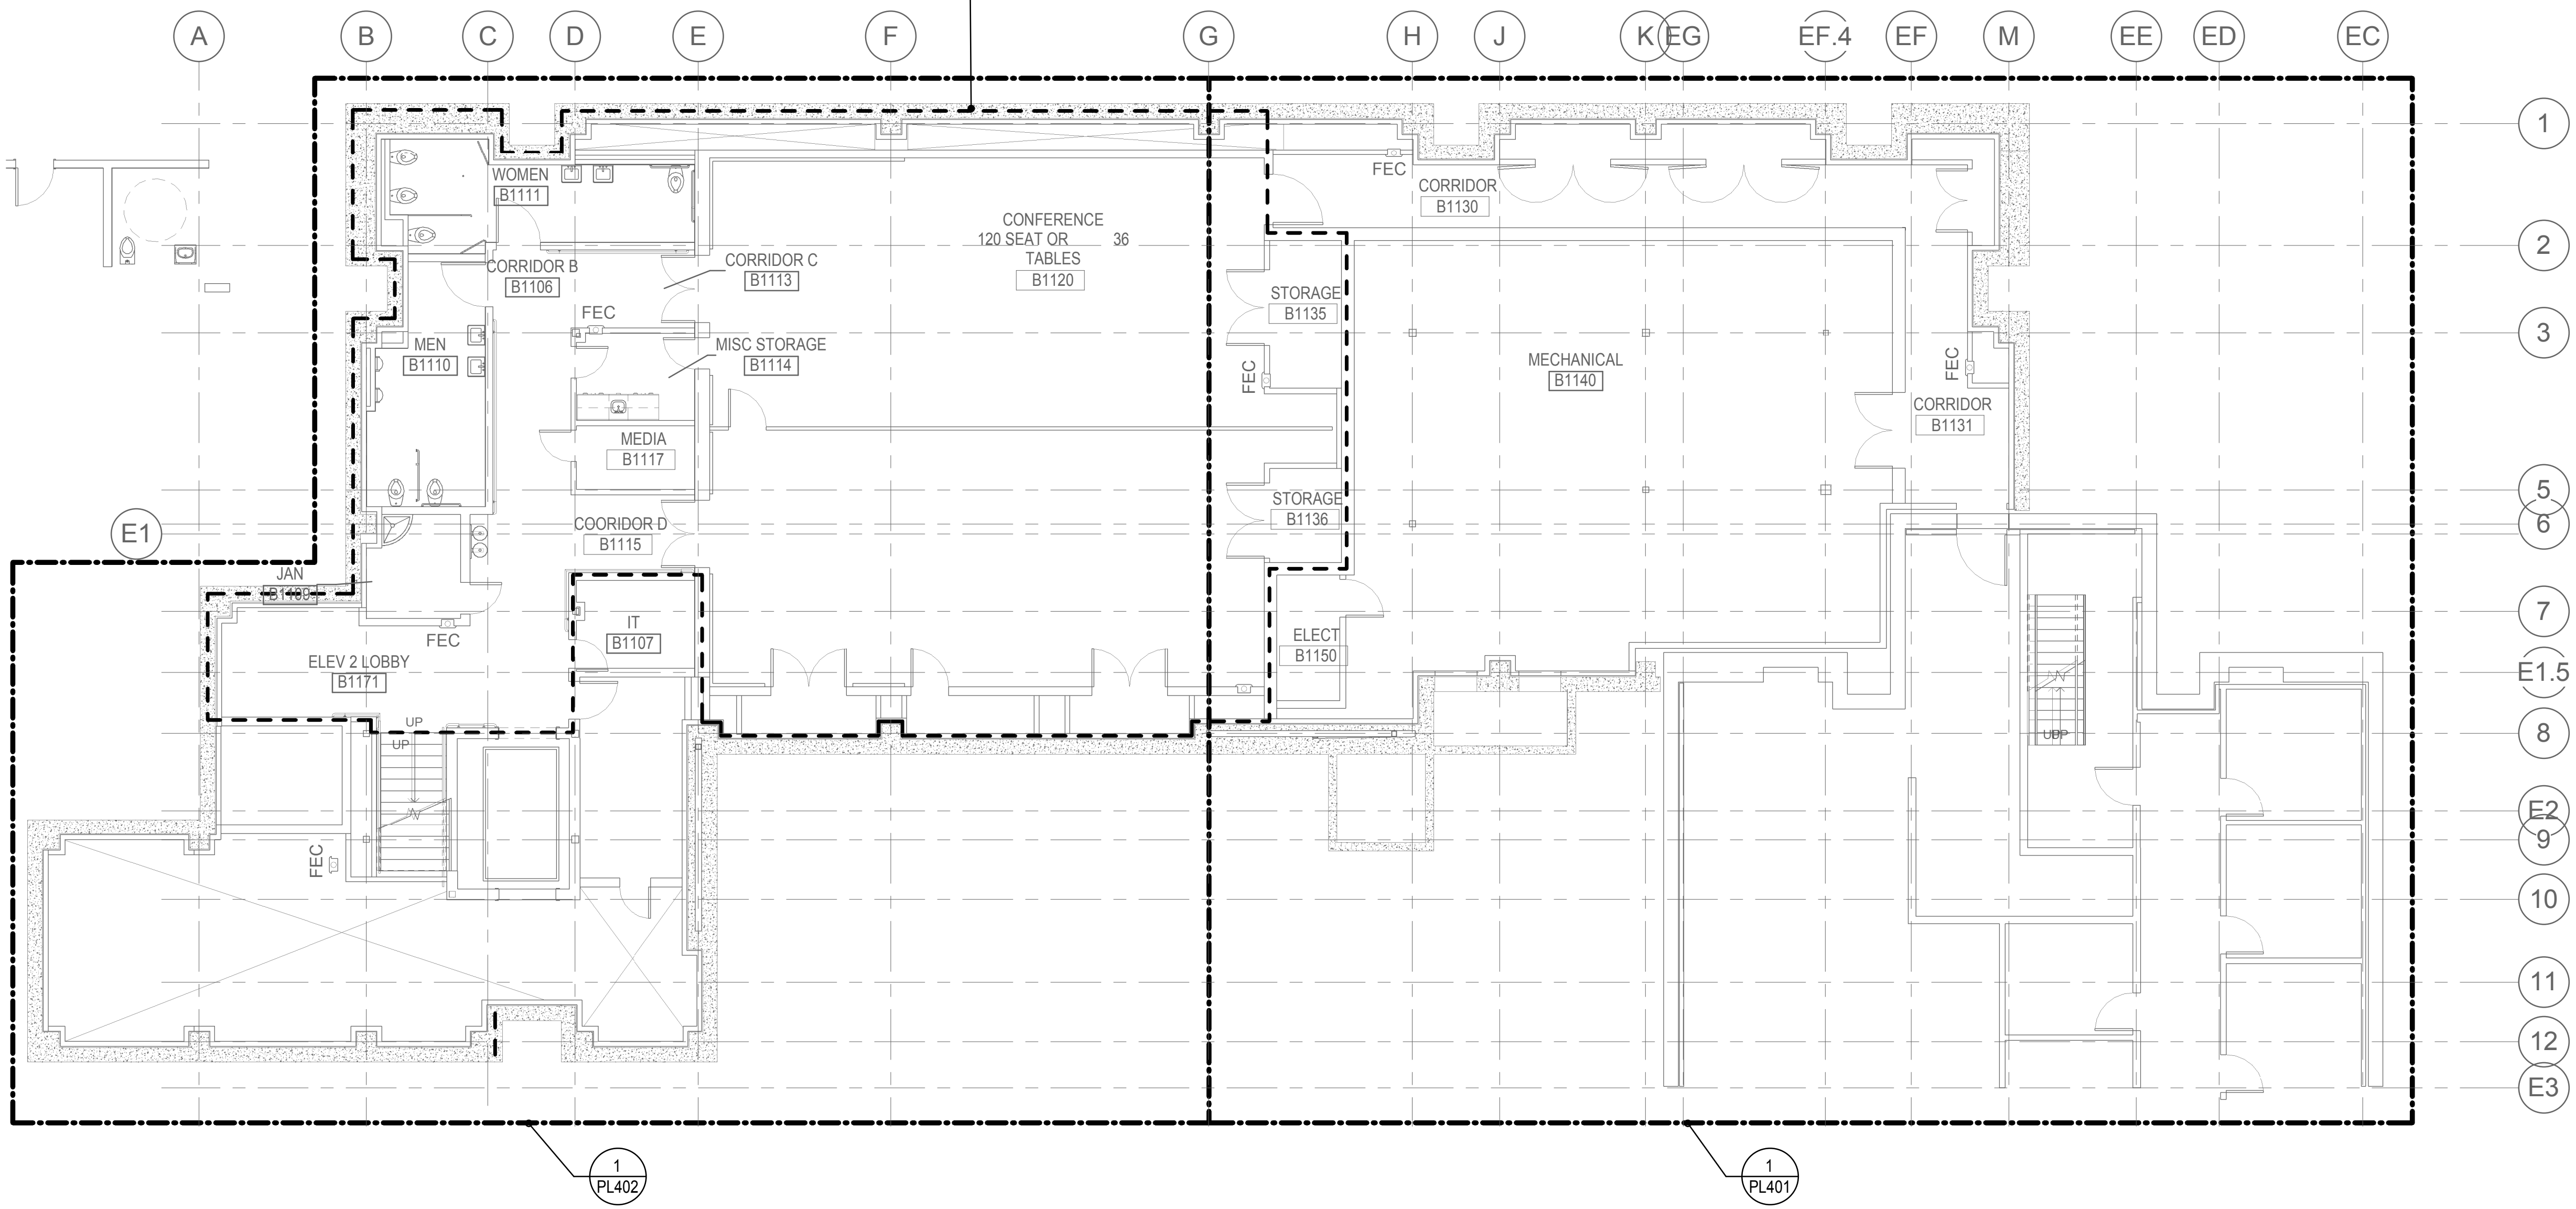

BASEMENT PLAN - PLUMBING
1/8" = 1'-0"


FFE = 1908'-0"

BID DOCUMENT
NOVEMBER/02/2015

	BID DOCUMENT	11/02/2015
	100% CONSTRUCTION DOCUMENT	1/26/2015
		12/30/14
	99% CONSTRUCTION DOCUMENT	12/17/14
	95% CONSTRUCTION DOCUMENT	10/13/14
	65% DESIGN DEVELOPMENT	6/27/14
	SCHEMATIC DESIGN	3/28/14
Revisions	ISSUES	Date

CONSULTANTS:

PROJECT 2013-0512
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TEL 503.382.2266
FAX 503.382.2262
www.interfaceengineering.com

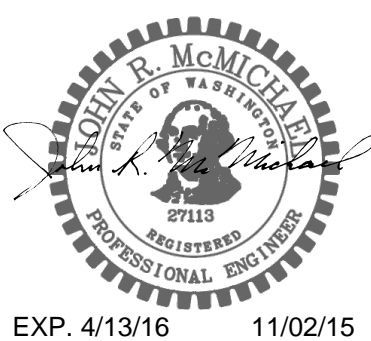

ARCHITECT/ENGINEERS:

KMA
ARCHITECTS
14410 SE Petrovitsky Rd. Suite 206
Renton, WA 98058
425-291-7078

Drawing Title
**BASEMENT LEVEL
PLUMBING PLAN**

Approved: Project Director
Approver

Project Title
**INTENSIVE OUTPATIENT MENTAL HEALTH
AND EDUCATION BUILDING**
SPOKANE VA MEDICAL CENTER
SPOKANE, WASHINGTON 99205

Location
SPOKANE, WASHINGTON 99205
Issue Date
11/02/2015


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JRM


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IEI



Project Number
668-313
Building Number
40A

Drawing Number
PL100
Dwg. of

Office of
Construction
and Facilities
Management

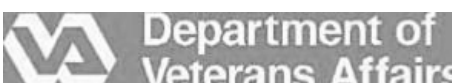

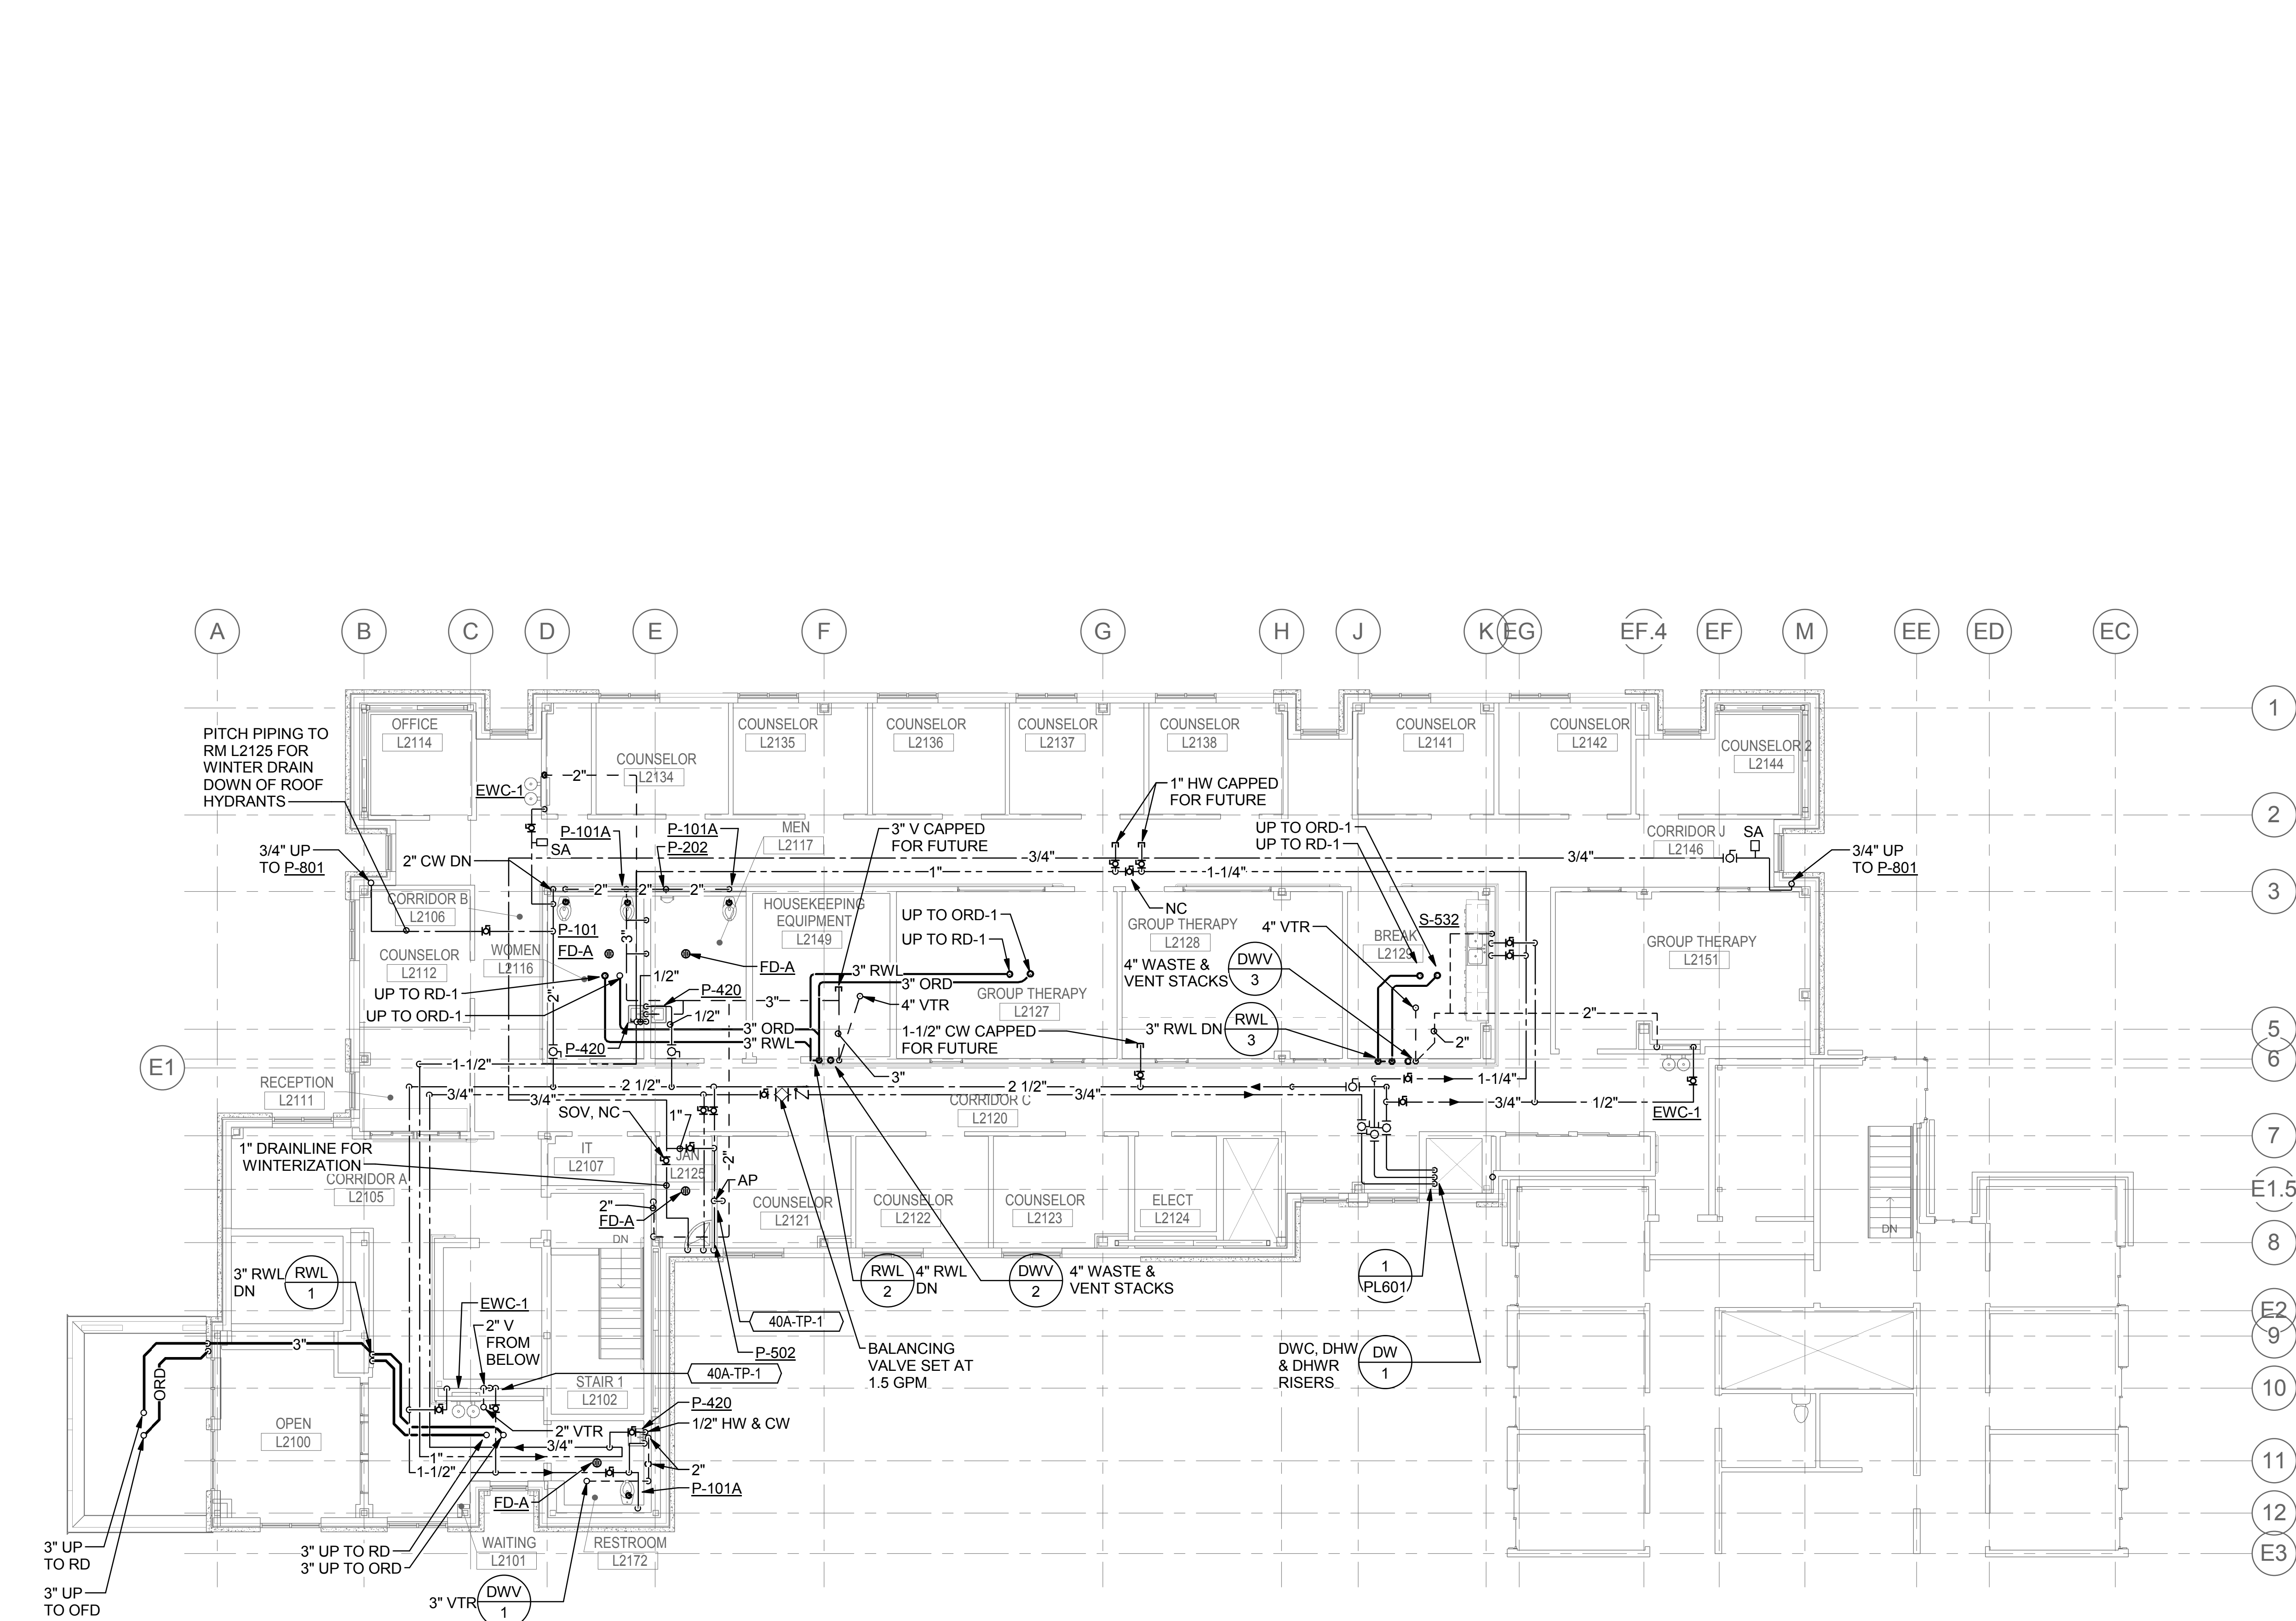

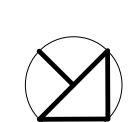
  **1** **LEVEL 2 PLAN - PLUMBING**
1/8" = 1'-0"

FFE = 1936'-0"


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	100% CONSTRUCTION DOCUMENT	1/26/2015
		12/30/14
	99% CONSTRUCTION DOCUMENT	12/17/14
	95% CONSTRUCTION DOCUMENT	10/13/14
	65% DESIGN DEVELOPMENT	6/27/14
	SCHEMATIC DESIGN	3/28/14
Revisions	ISSUES	Date

CONSULTANTS:

PROJECT 2013-0512
CONTACT John McMichael




100 SW Main Street
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FAX 503.382.2262
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EXP. 4/13/16 11/02/15

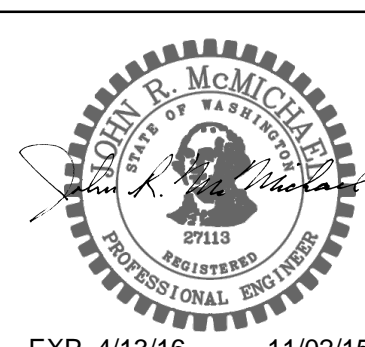ARCHITECT/ENGINEERS:



14410 SE Petrovitsky Rd. Suite 206
Renton, WA 98058
425-291-7078

Drawing Title
LEVEL 2 PLUMBING PLAN

Approved: Project Director
Approver

Project Title
INTENSIVE OUTPATIENT MENTAL HEALTH AND EDUCATION BUILDING
SPOKANE VA MEDICAL CENTER
SPOKANE, WASHINGTON 99205

Location
SPOKANE, WASHINGTON 99205

Issue Date
11/02/2015

Checked
JRM

Drawn
IEI

Project Number
668-313

Building Number
40A

Drawing Number
PL102



Dwg. of

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Construction
and Facilities
Management



SHEET KEYNOTES

- 1 REFER TO ARCHITECTURAL DETAILS FOR FLASHING OF VTR'S AND INSTALLATION OF ROOF DRAINS IN ROOFING SYSTEM, TYPICAL

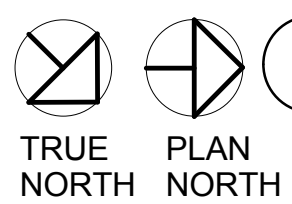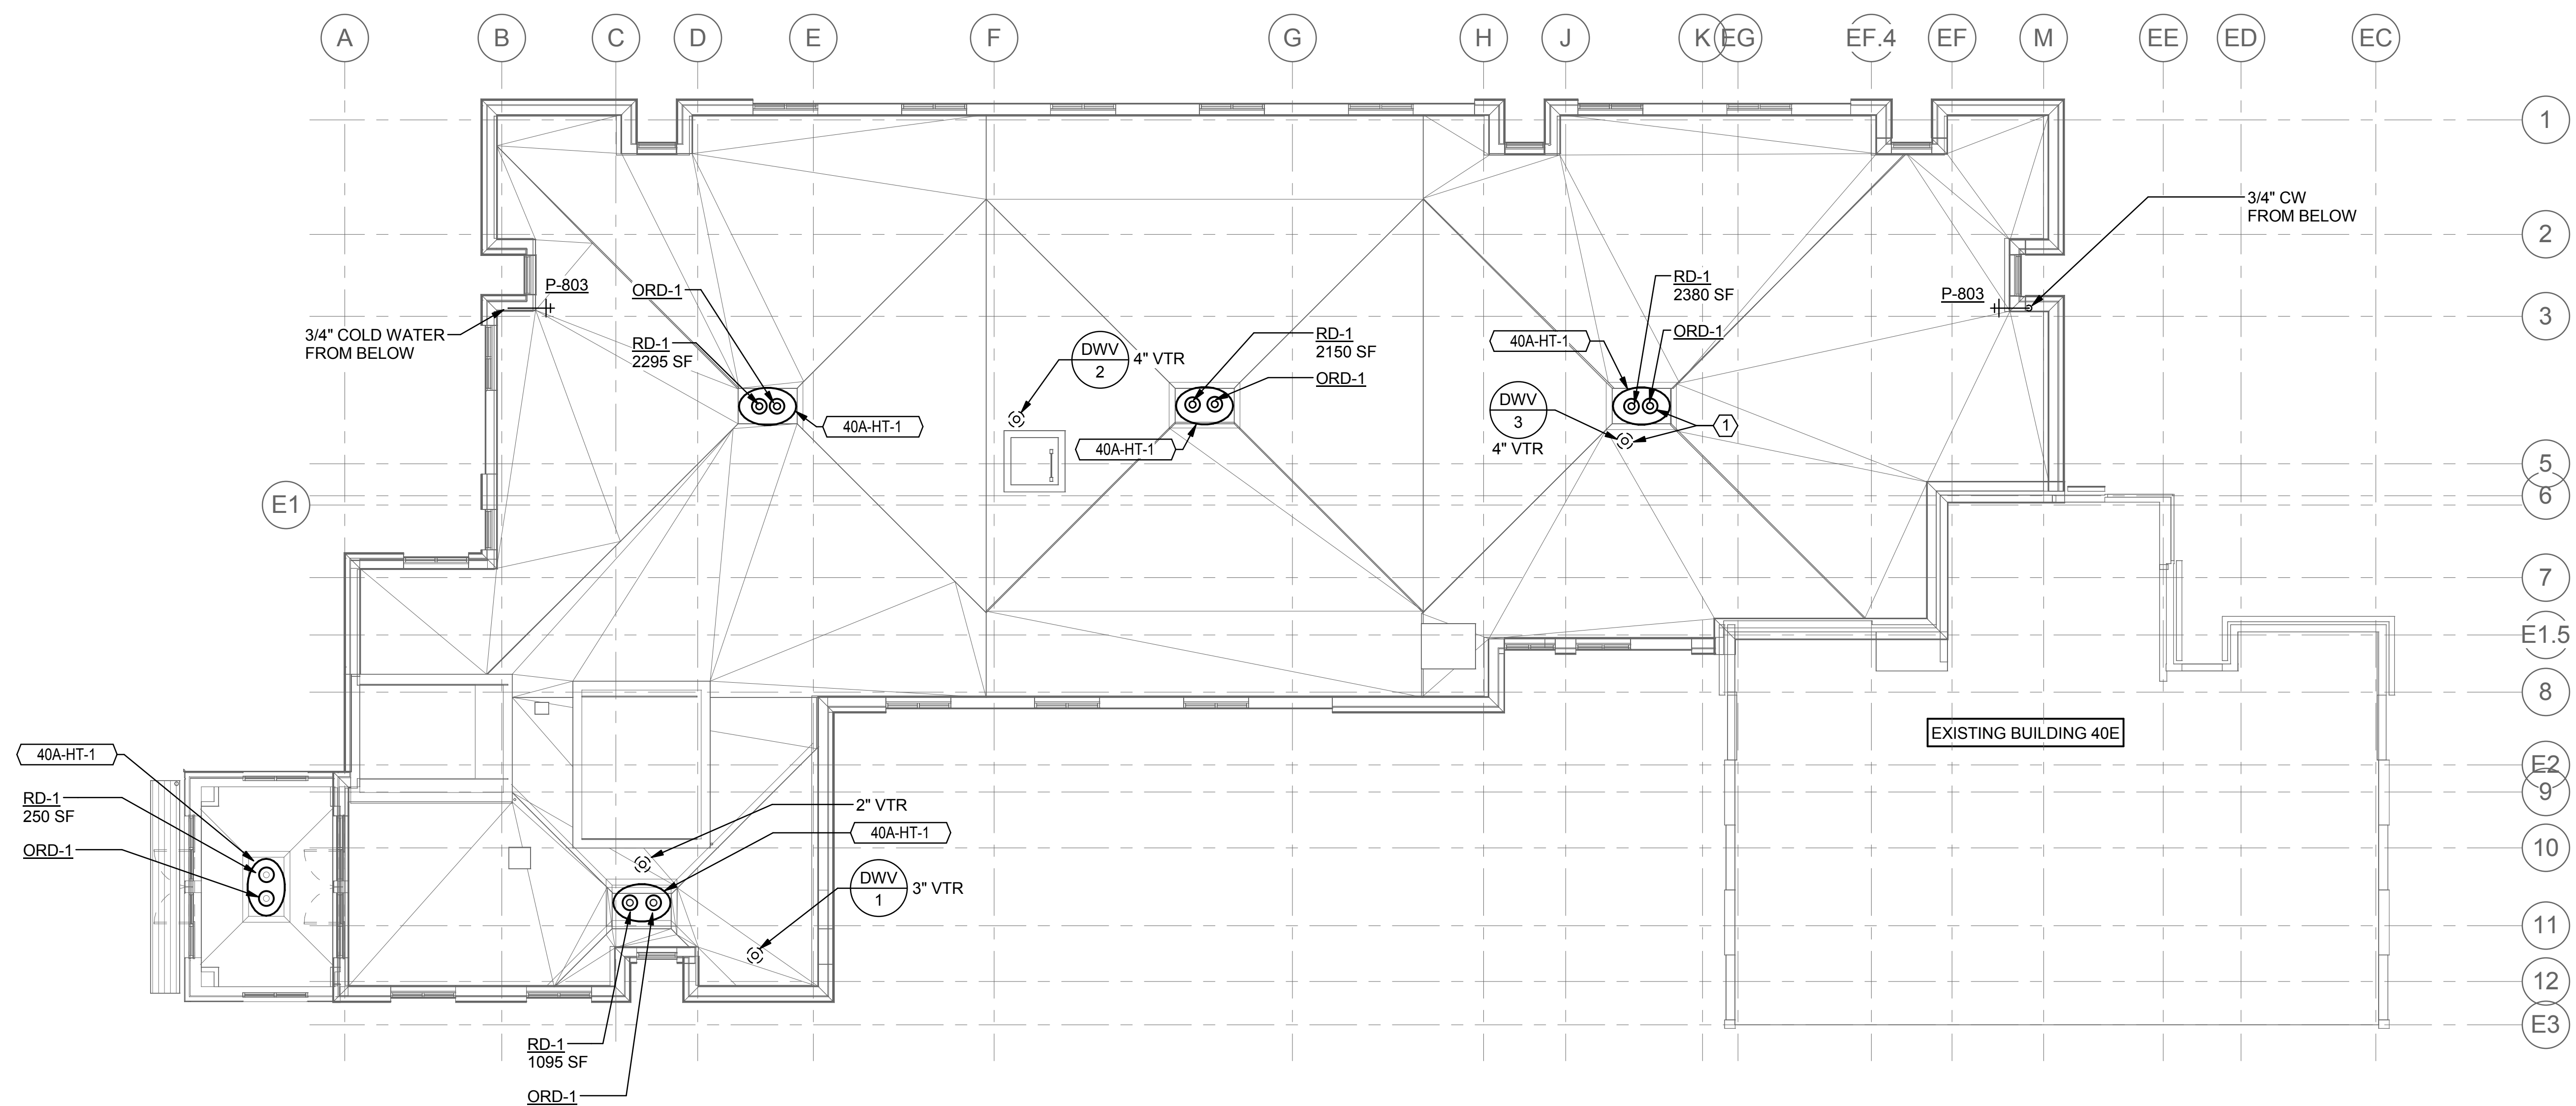

ROOF PLAN - PLUMBING

1/8" = 1'-0"

FFE = 1949'-5"

BID DOCUMENT
NOVEMBER/02/2015

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three inches = one foot
one and one half inches = one foot
one inch = one foot
three quarters inch = one foot
three eighths inch = one foot
one quarter inch = one foot
one eighth inch = one foot

GENERAL PLUMBING NOTES


A. MECHANICAL ROOM EQUIPMENT ACCESS WAY, REFER TO HVAC SHEET MH304.

SHEET KEYNOTES

1. INSTALL TOP OF DRAIN -1' BELOW FINISHED FLOOR SLAB. SLOPE CONCRETE TO DRAIN. COORDINATE WITH DIVISION 3 WORK.
2. DISCONNECT EXISTING 4" DOMESTIC WATER SERVICE TO BACKFLOW PREVENTOR AND CAP-OFF TO CLEAR FOR NEW CONSTRUCTION. CONNECT NEW 4" COLD WATER MAIN FROM BUILDING 40A TO EXISTING BACKFLOW PREVENTOR. PROVIDE A TEMPORARY COLD WATER FEED TO BUILDING 40 DURING BUILDING 40A CONSTRUCTION. BUILDING 40 TO REMAIN OPERATIONAL DURING BUILDING 40A CONSTRUCTION.
3. CONTRACTOR TO DISCONNECT, REMOVE AND REPLACE (E) PIPING TO DOMESTIC WATER AS SHOWN ON DETAIL 4/PL501.

DEDUCTIVE ALTERNATE BID AREA #1 CONSTRUCTION NOTES:

1. DELETE ALL PLUMBING FIXTURES AND DRAINS FROM SCOPE OF WORK EXCEPT P-801 WALL HYDRANTS.
2. ROUGH-IN FOR ALL PLUMBING FIXTURES AND DRAINS SHOWN IN ALTERNATE BID AREA #1.

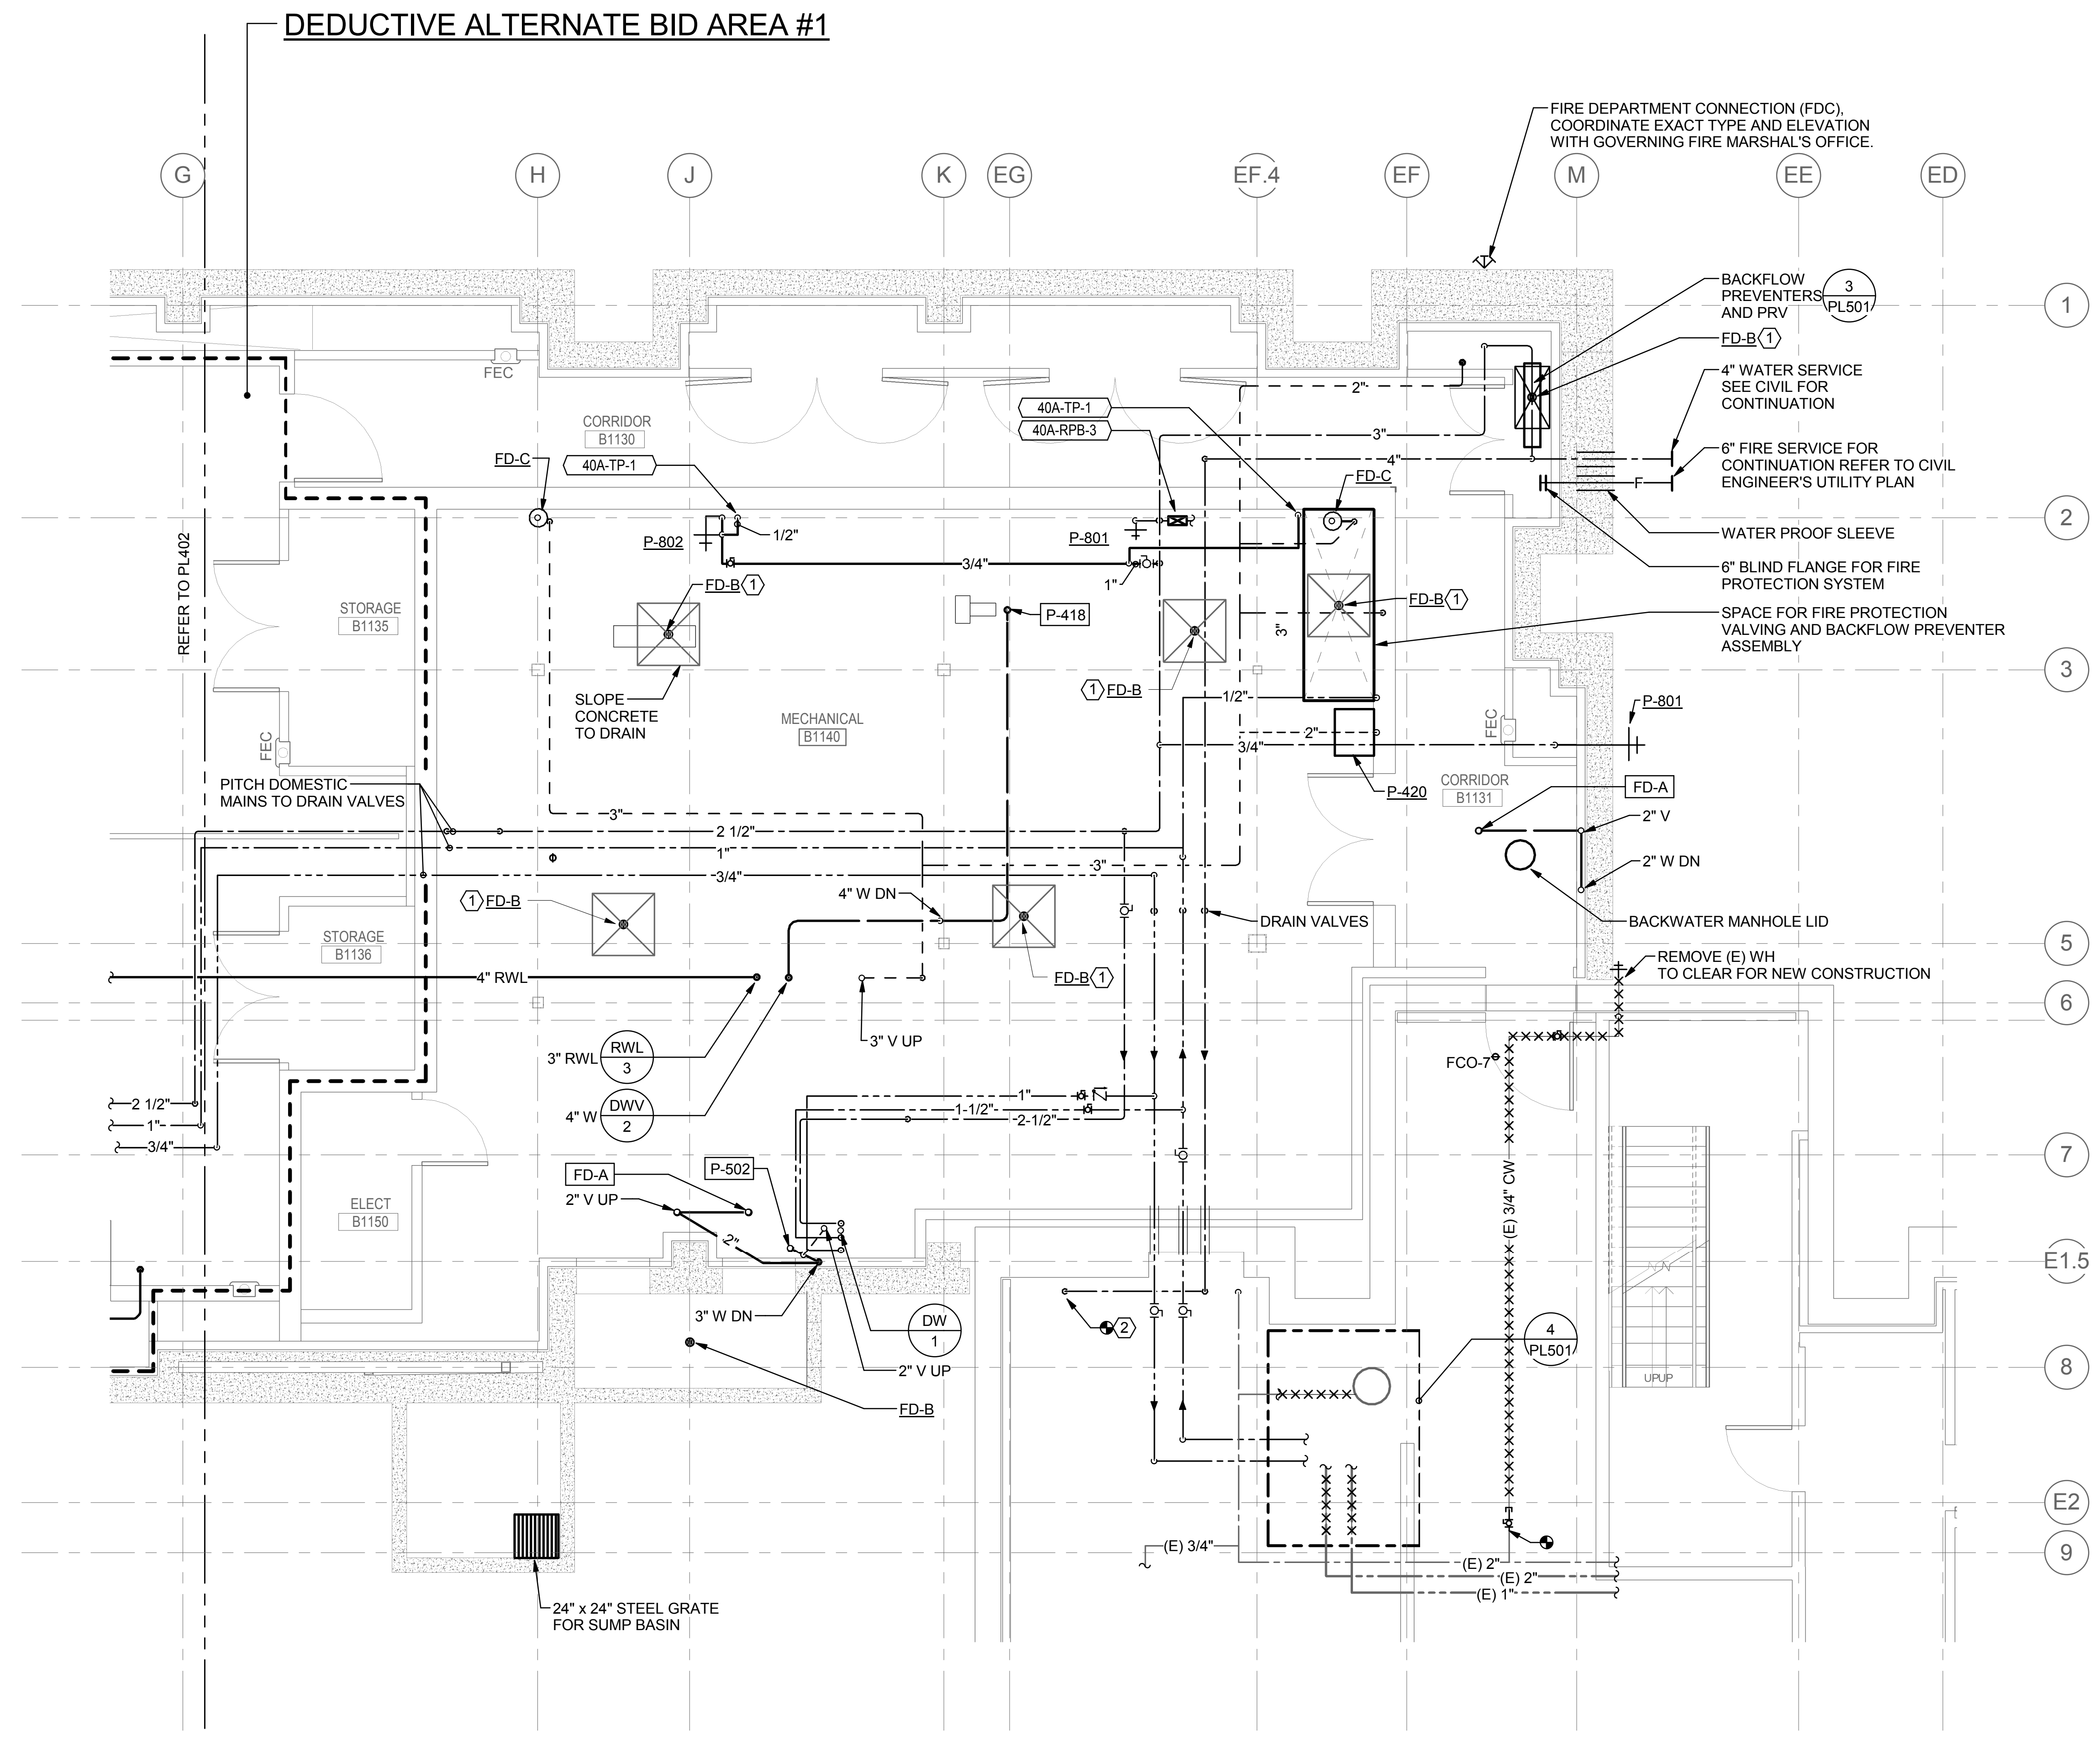

1 PARTIAL BASEMENT PLAN - NORTH - PLUMBING
1/4" = 1'-0"

FFE = 1907' - 4"

BID DOCUMENT
NOVEMBER/02/2015

				CONSULTANTS:				ARCHITECT/ENGINEERS:		Drawing Title		Project Title		Project Number		Office of Construction and Facilities Management	
		BID DOCUMENT		11/02/2015						PARTIAL FLOOR PLANS - PLUMBING		INTENSIVE OUTPATIENT MENTAL HEALTH AND EDUCATION BUILDING		668-313			
		100% CONSTRUCTION DOCUMENT		1/26/2015								SPOKANE VA MEDICAL CENTER SPOKANE, WASHINGTON 99205		Building Number			
				12/30/14										40A			
		99% CONSTRUCTION DOCUMENT		12/17/14												Drawing Number	
		95% CONSTRUCTION DOCUMENT		10/13/14												PL401	
		65% DESIGN DEVELOPMENT		6/27/14													
		SCHEMATIC DESIGN		3/28/14												Dwg. of	
Revisions		ISSUES		Date								Approved: Project Director		Location SPOKANE, WASHINGTON 99205			
												Approver		Issue Date		Checked	
														11/02/2015		JRM	
																Drawn	
																IEI	



DEDUCTIVE ALTERNATE BID AREA #1

GENERAL PLUMBING NOTES

A. ALL PIPING IN CONFERENCE ROOM B1120 AND BETWEEN GRIDS E/1 & H/1 AND E/8 & H/8 SHALL BE ACUSTICALLY WRAPPED WITH KINETICS KNM-100ALQ OR EQUAL.

DEDUCTIVE ALTERNATE BID AREA #1
CONSTRUCTION NOTES:


1. DELETE ALL PLUMBING FIXTURES AND DRAINS FROM SCOPE OF WORK EXCEPT P-801 WALL HYDRANTS.
2. ROUGH-IN FOR ALL PLUMBING FIXTURES AND DRAINS SHOWN IN ALTERNATE BID AREA #1.

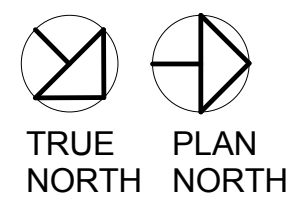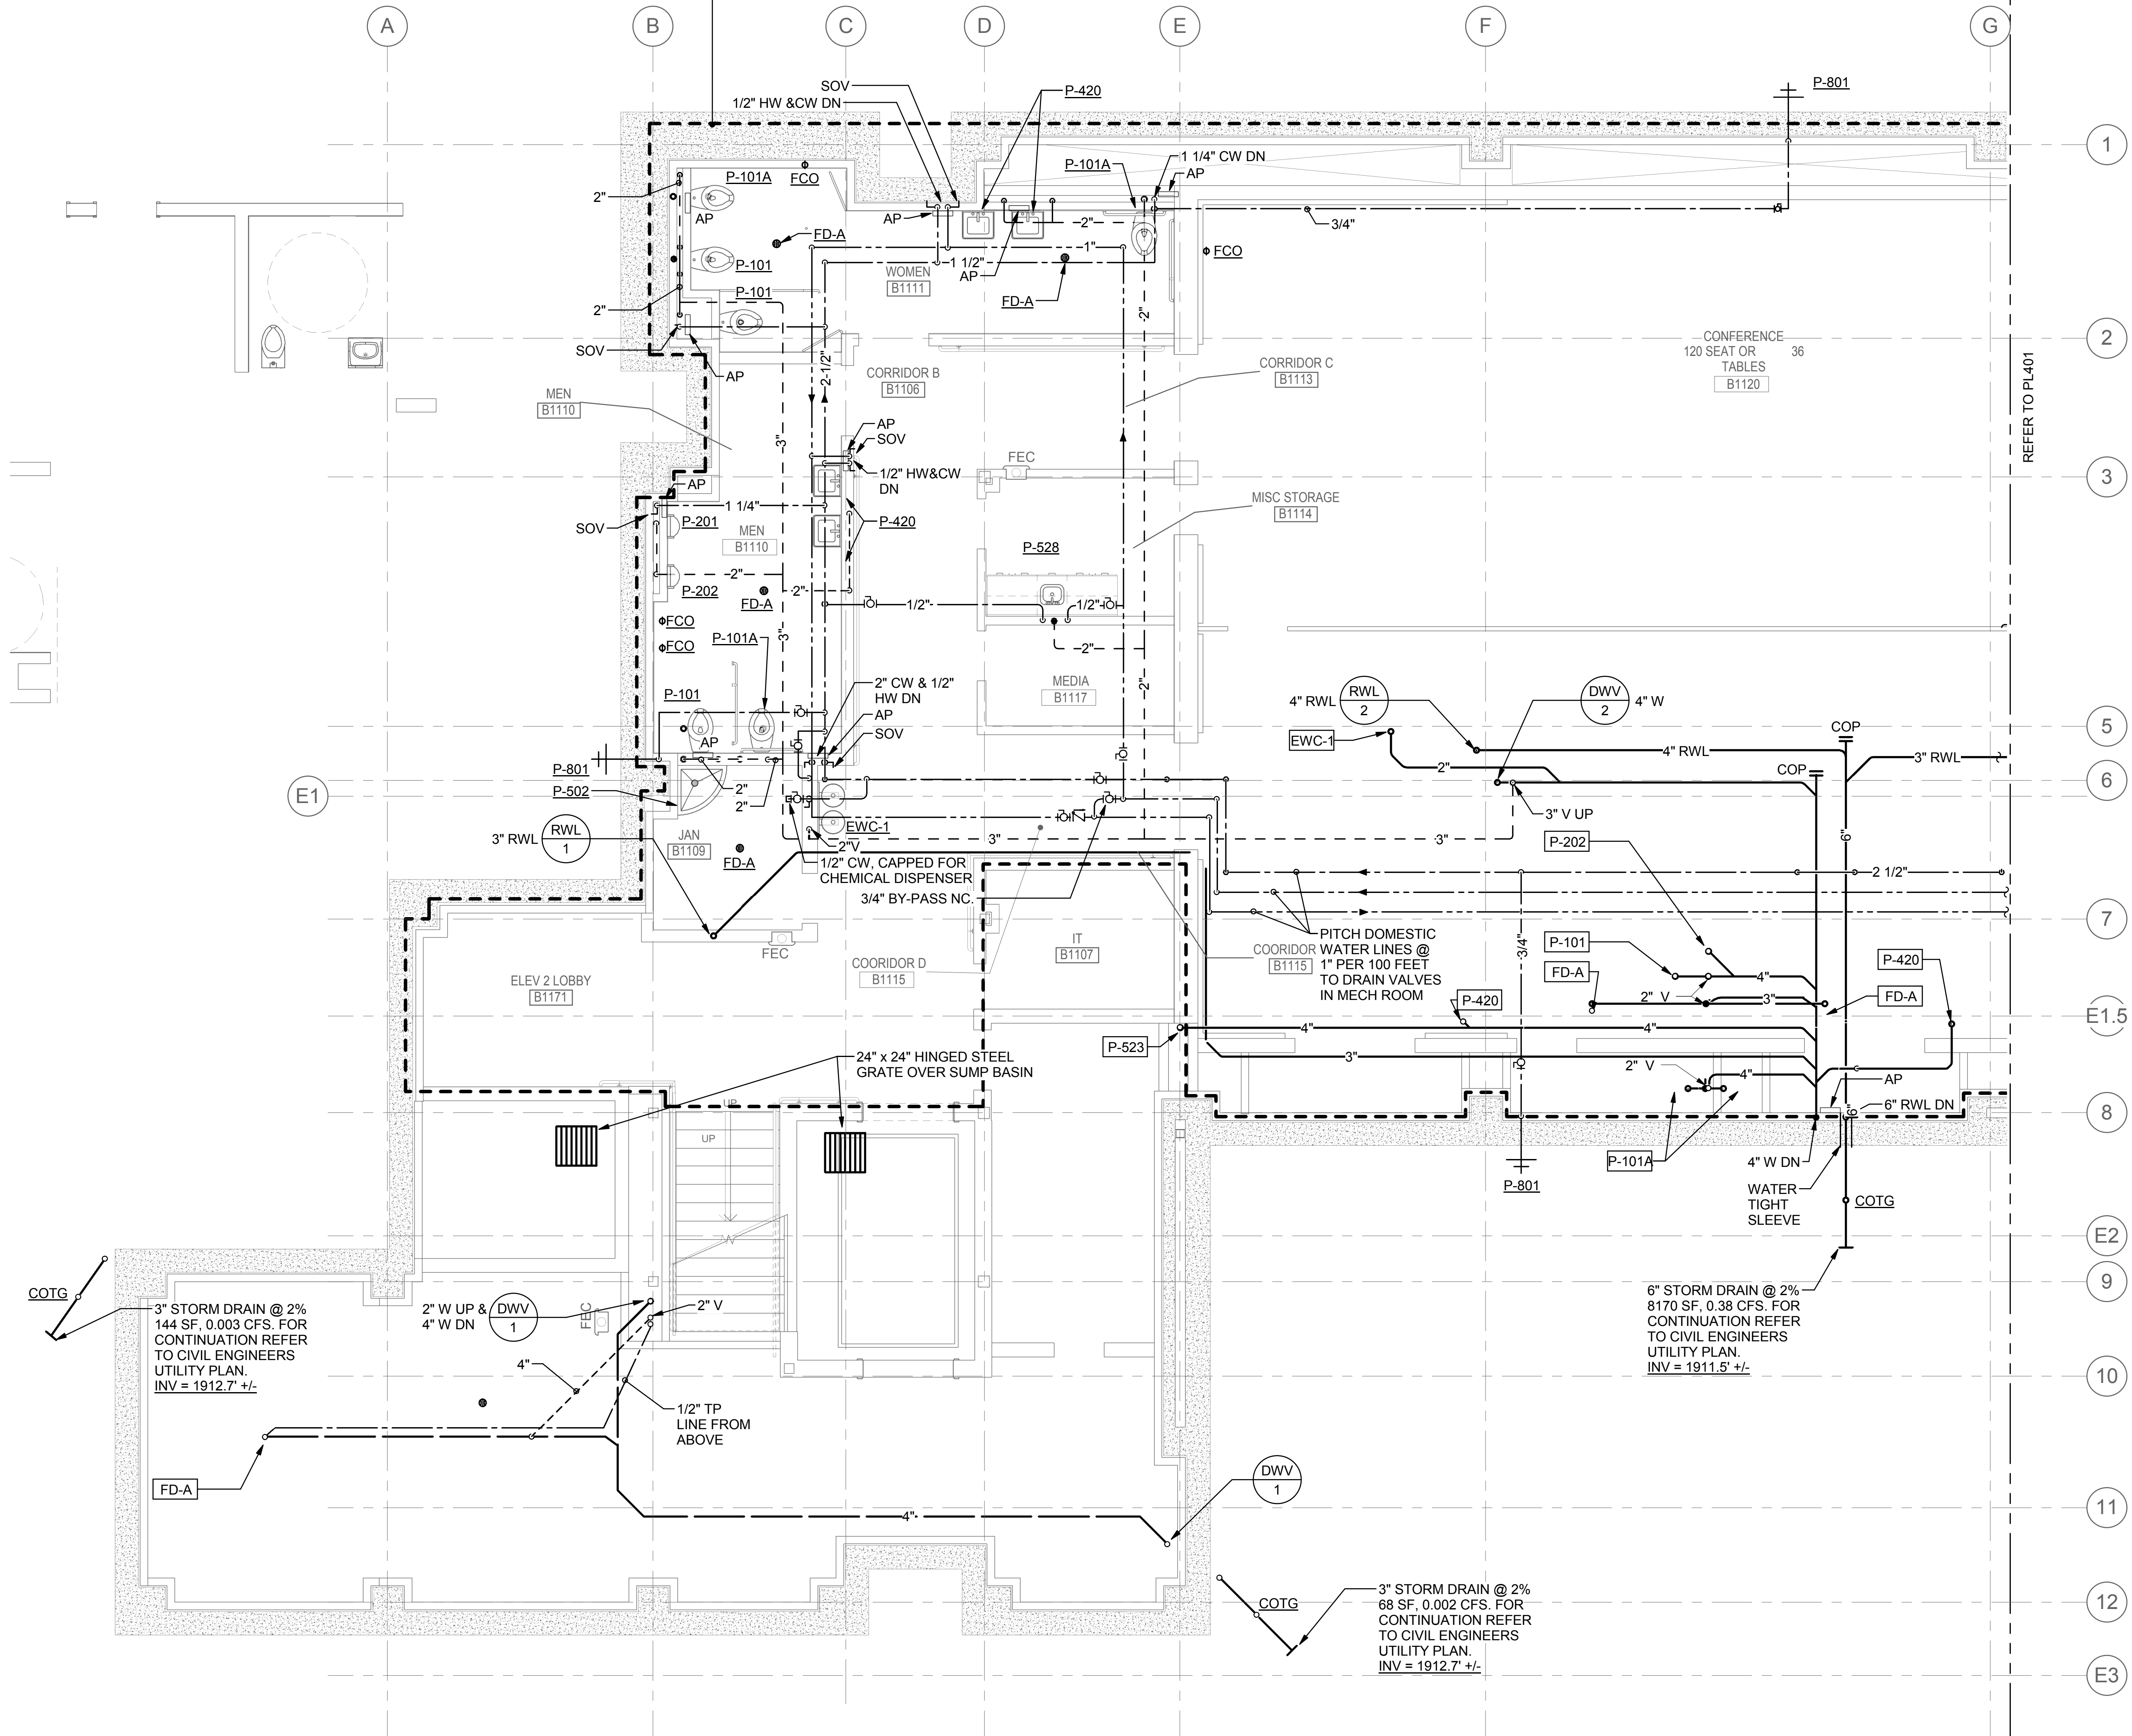

PARTIAL BASEMENT PLAN - SOUTH - PLUMBING
1/4" = 1'-0"

CONSULTANTS:

PROJECT 2013-0512
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Drawing Title
**PARTIAL FLOOR PLAN -
PLUMBING**

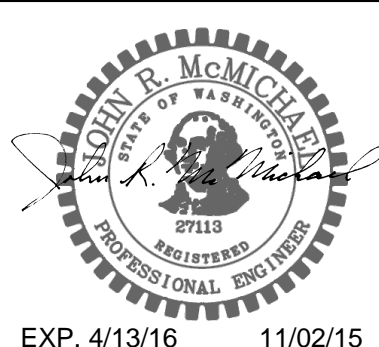Approved: Project Director
Approver

Project Title
**INTENSIVE OUTPATIENT MENTAL HEALTH
AND EDUCATION BUILDING**
SPOKANE VA MEDICAL CENTER
SPOKANE, WASHINGTON 99205

Location
SPOKANE, WASHINGTON 99205

Issue Date
11/02/2015

Checked
JRM

Drawn
IEI

Project Number
668-313


Building Number
40A

Drawing Number
PL402

Dwg. of

Office of
Construction
and Facilities
Management

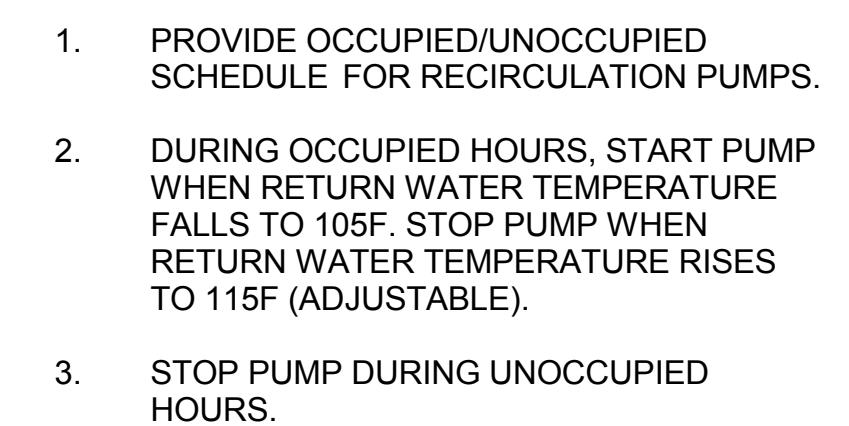


 Department of
Veterans Affairs

A PITCH ALL PIPING MAINS AT 1" PER 100 TOWARD DRAIN VALVES IN JANITOR'S CLOSET OR MECHANICAL ROOMS. NO TRAPPED LINES PERMITTED IN DOMESTIC WATER PIPING.

B PROVIDE SHOCK ARRESTORS WITH ACCESS PANELS.


- 1 PIPING MAINS SHALL BE PITCHED AT 1" PER 100 FEET TOWARD DRAIN VALVES - OVER P=502 IN ROOM L2125.
- 2 PITCH PIPING AT 1" PER 100 FEET TOWARD DRAIN VALVES OVER P-502 IN ROOM L1150.

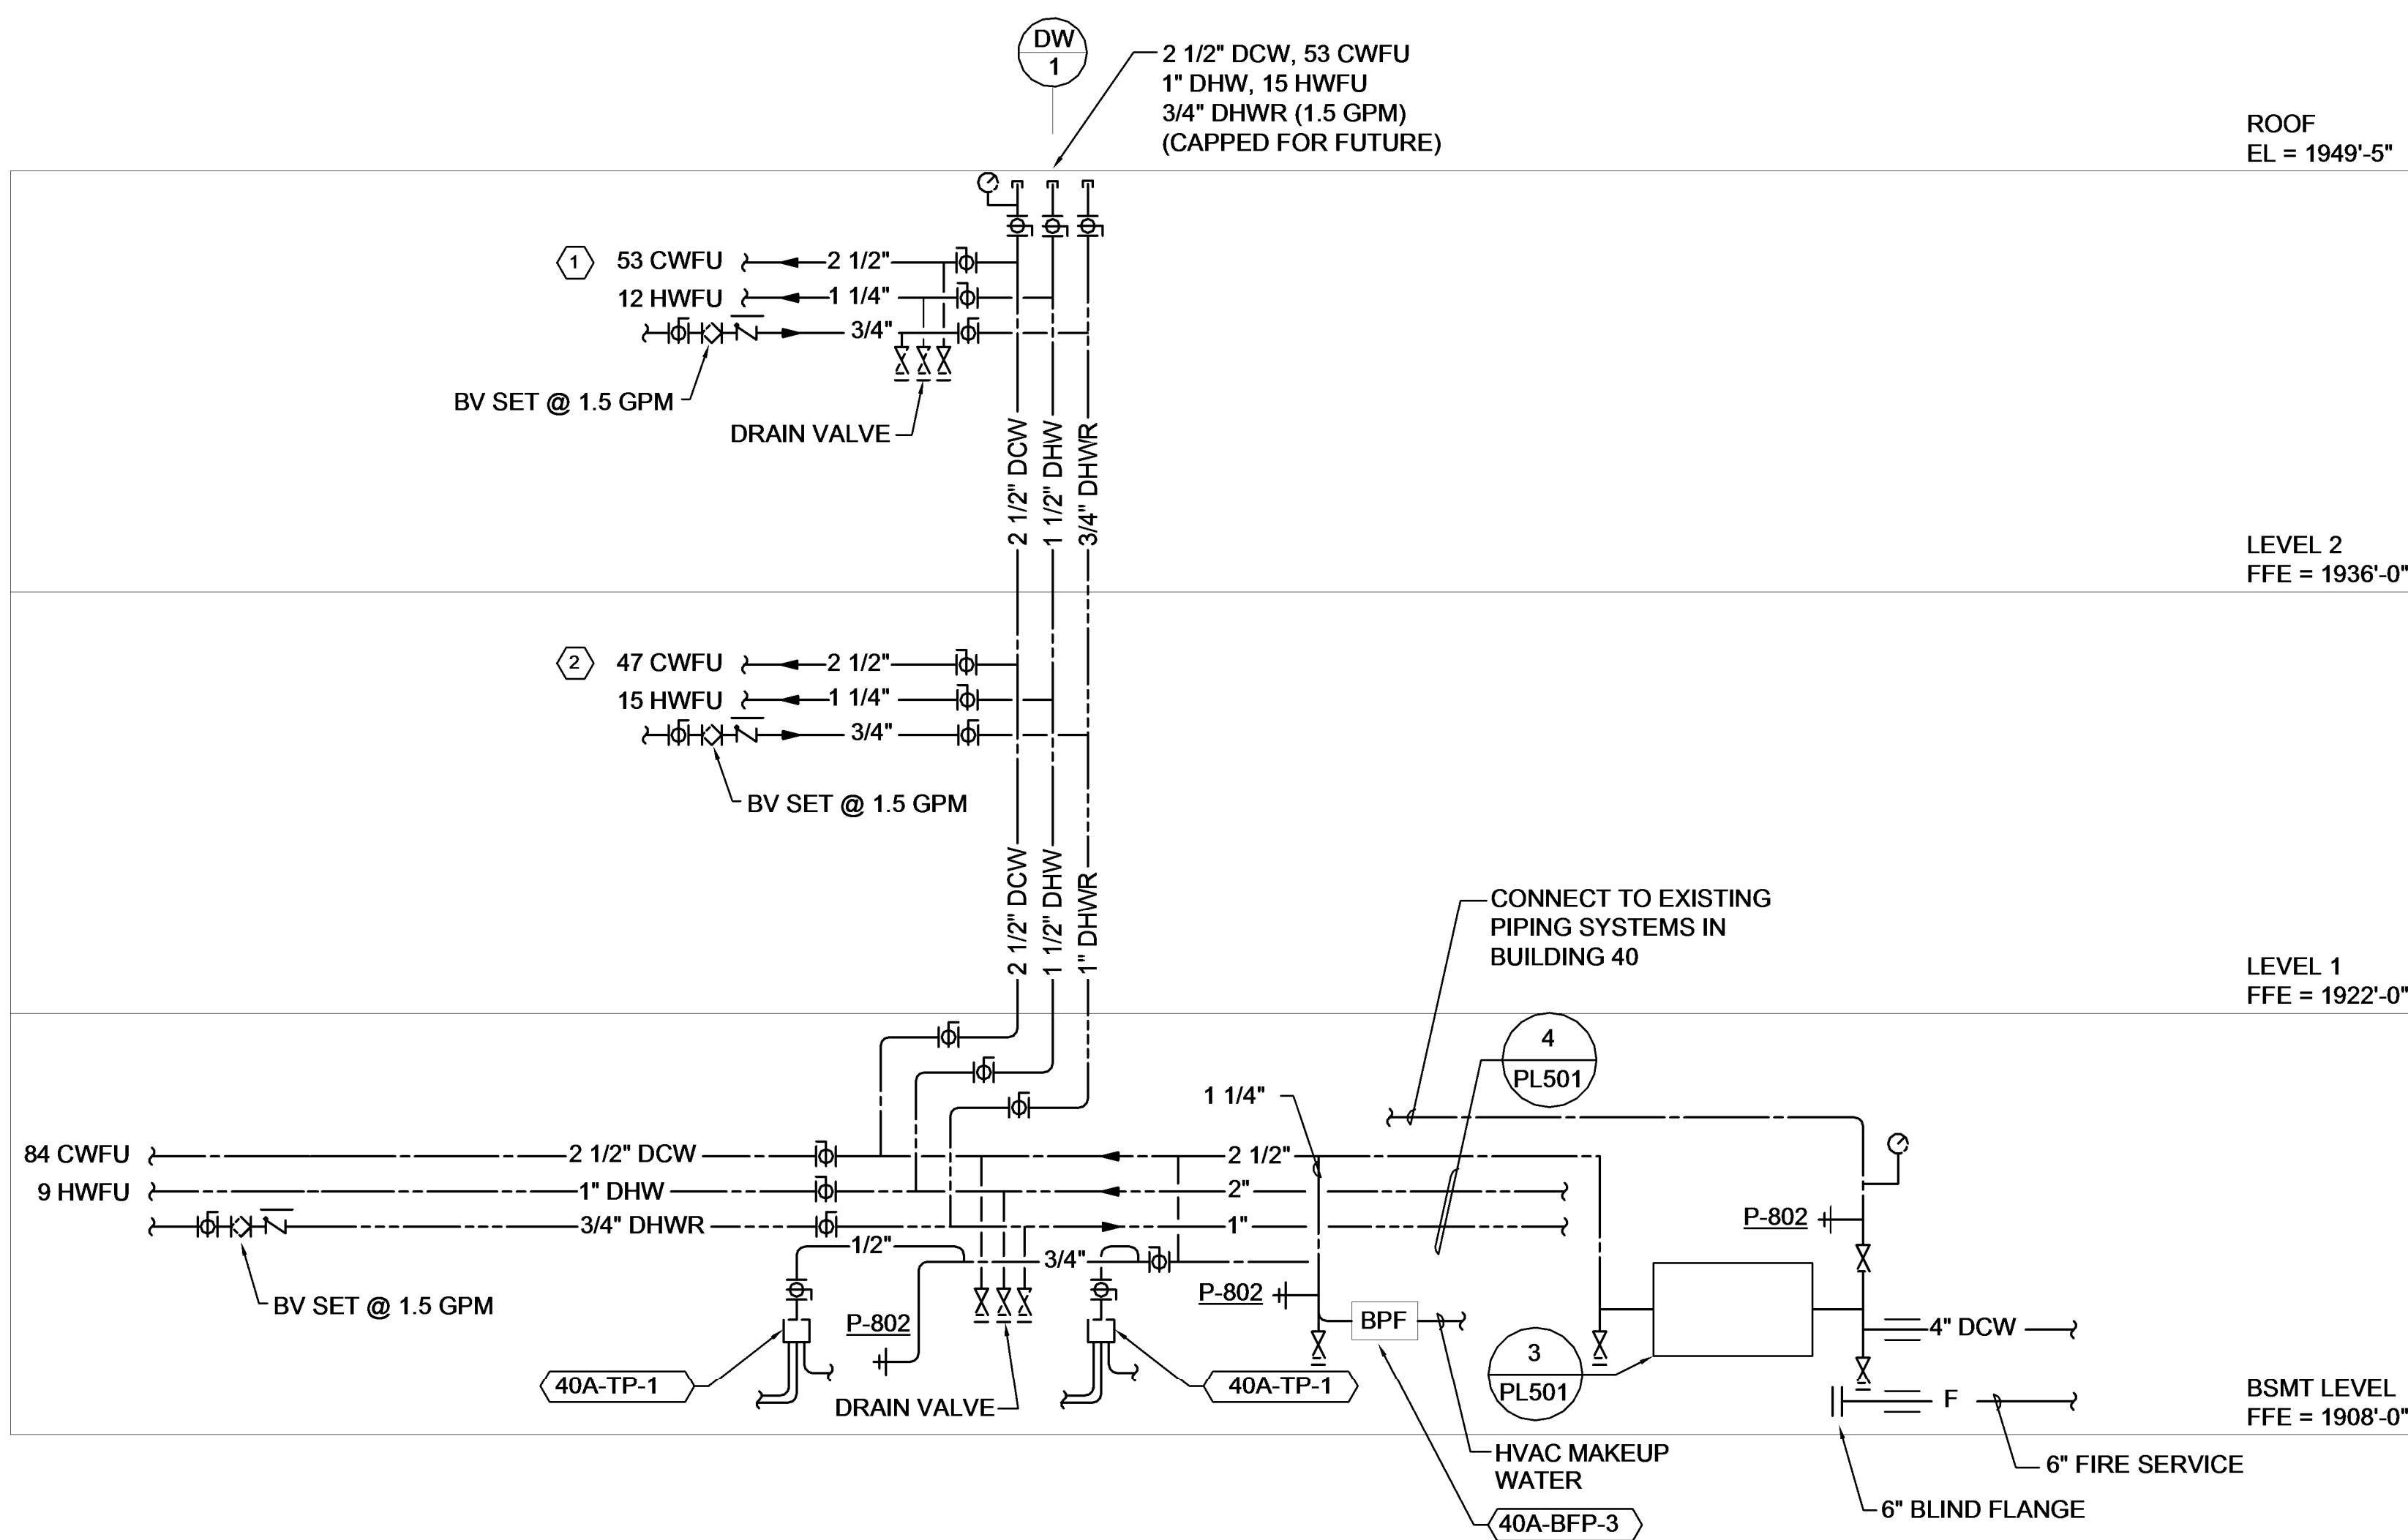

1 DOMESTIC WATER RISER DIAGRAM
NO SCALE

[illegible]

three inches = one foot
one and one half inches = one foot
one inch = one foot
three quarters inch = one foot
one half inch = one foot
three eighths inch = one foot
one quarter inch = one foot
one eighth inch = one foot

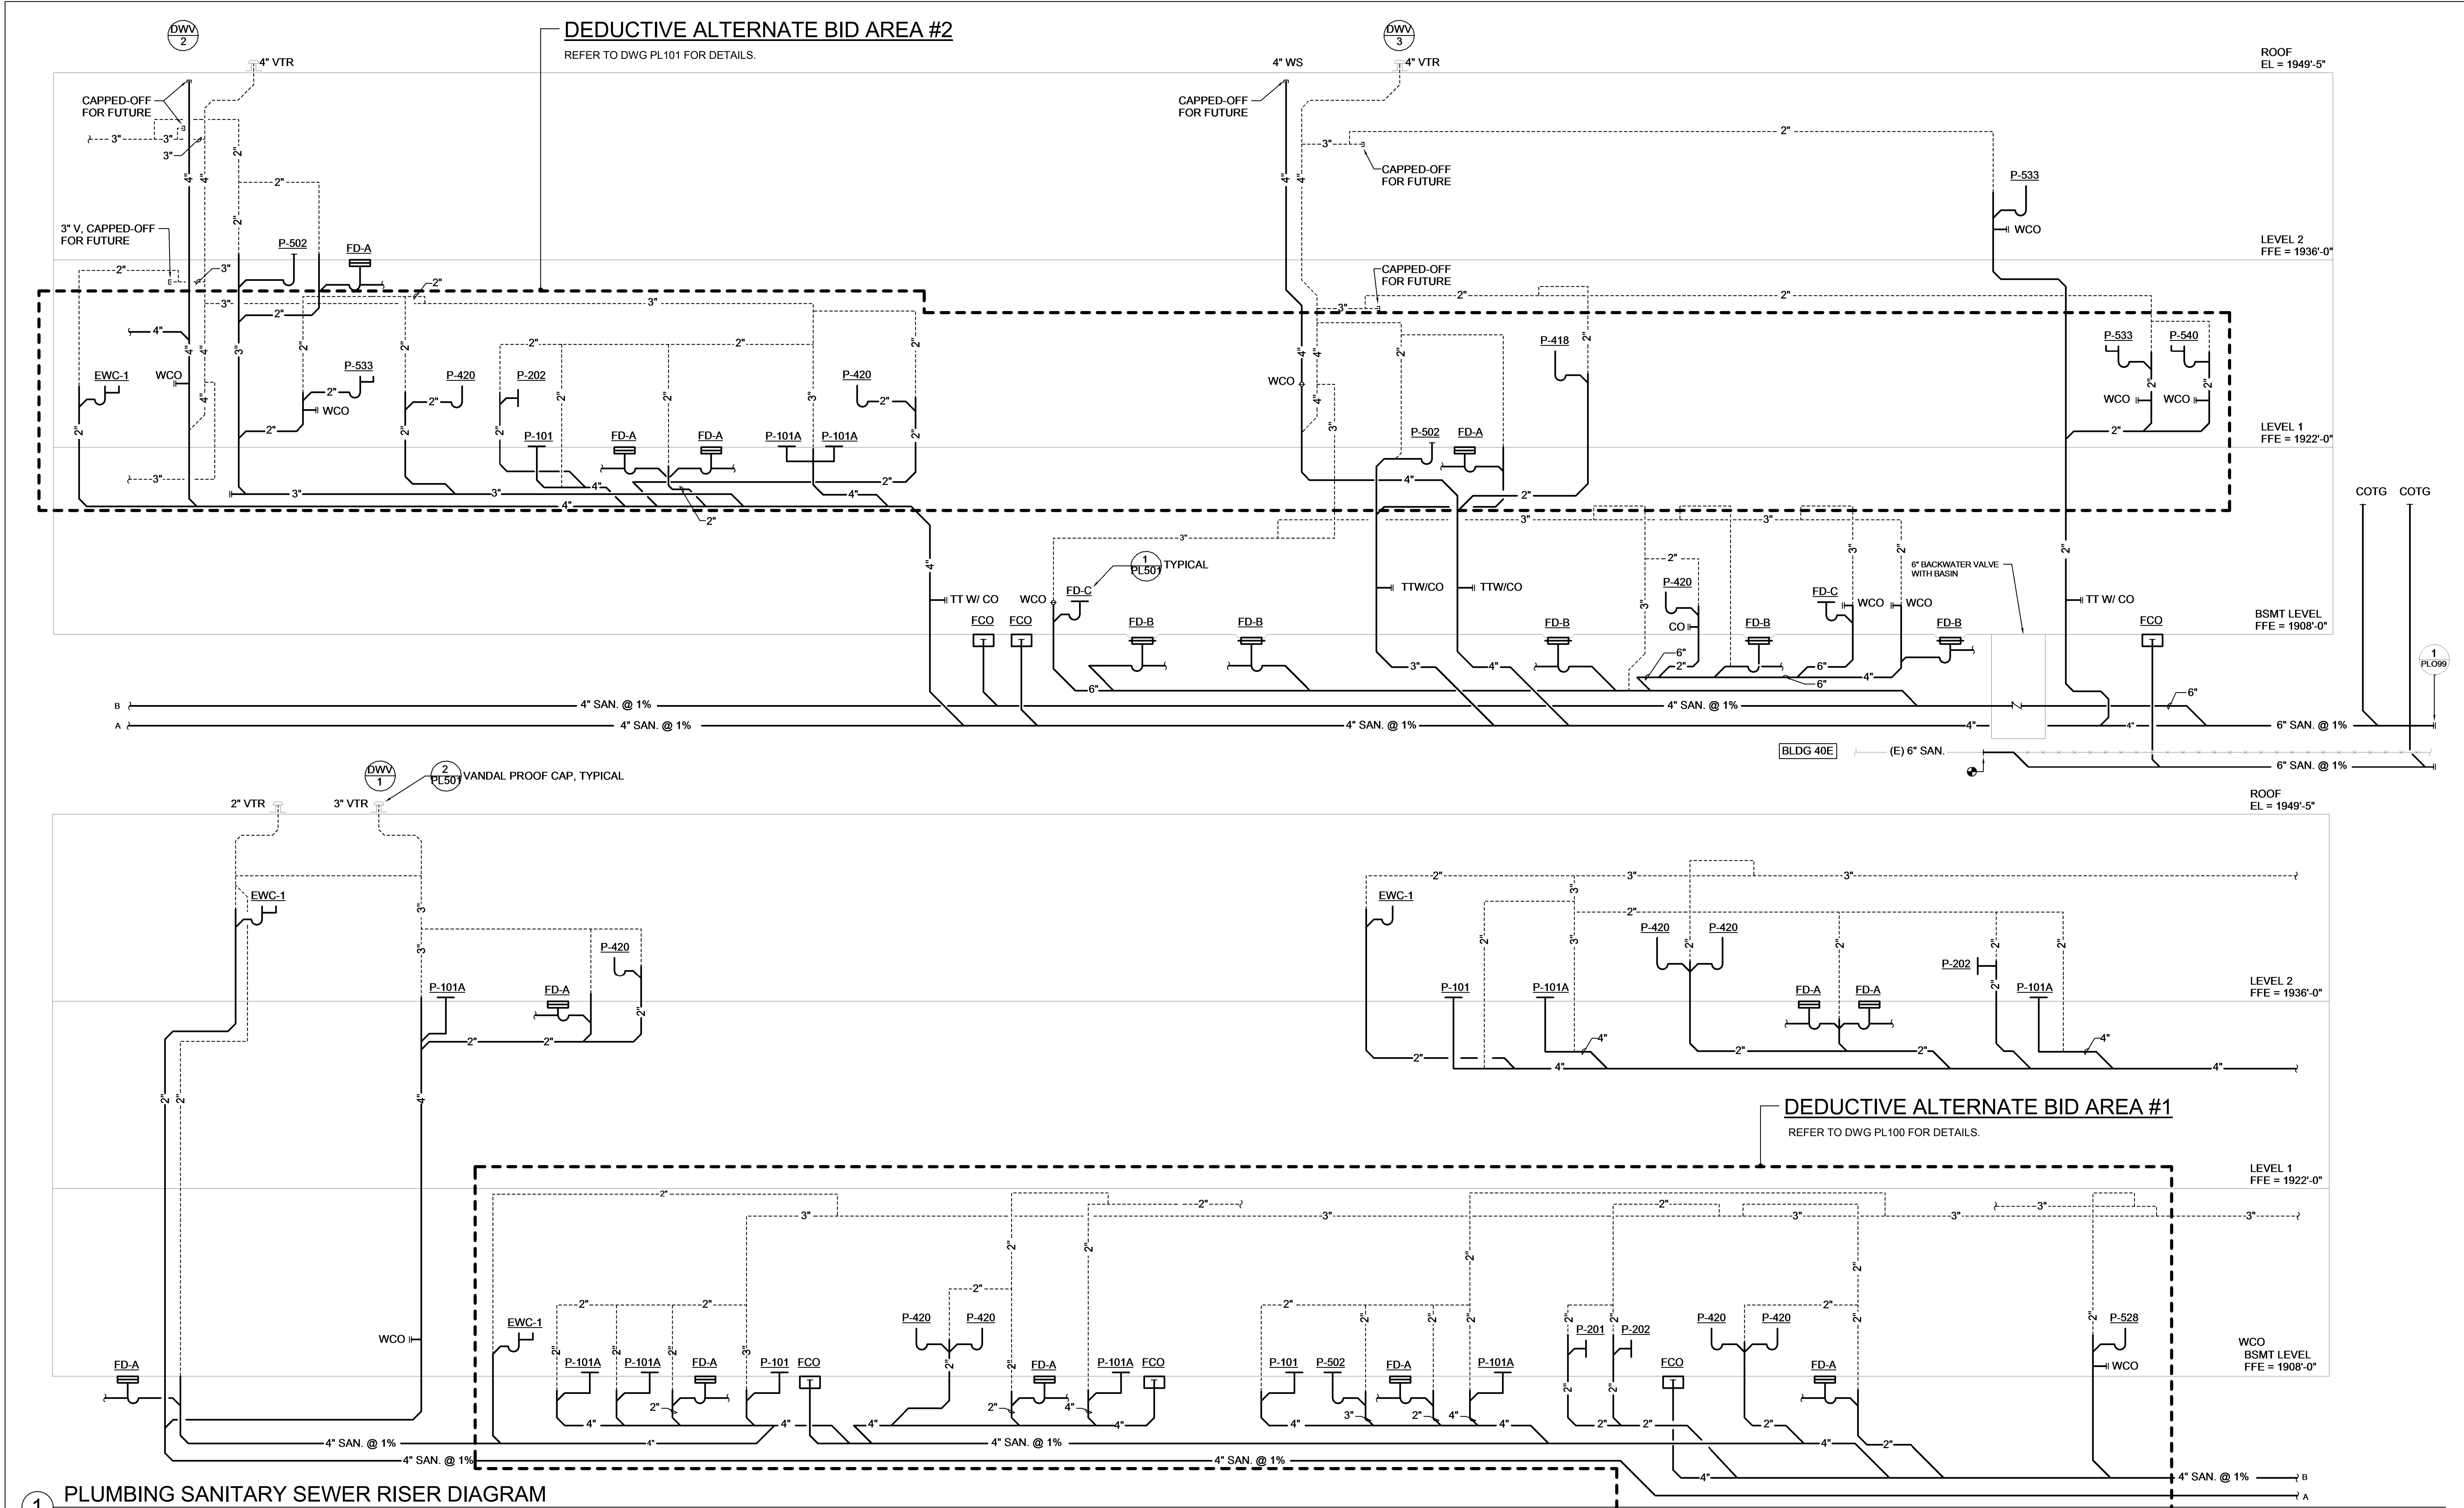

1 PLUMBING SANITARY SEWER RISER DIAGRAM
NO SCALE

DEDUCTIVE ALTERNATE BID AREA #1
REFER TO DWG PL100 FOR DETAILS.


DEDUCTIVE ALTERNATE BID AREA #2
REFER TO DWG PL101 FOR DETAILS.

BID DOCUMENT 11/02/2015		CONSULTANTS:		ARCHITECT/ENGINEERS:		Drawing Title PLUMBING RISER DIAGRAMS		Project Title INTENSIVE OUTPATIENT MENTAL HEALTH AND EDUCATION BUILDING		Project Number 668-313		Office of Construction and Facilities Management Department of Veterans Affairs	
100% CONSTRUCTION DOCUMENT 1/26/2015		PROJECT 2013-0512 CONTACT John McMichael INTERFACE ENGINEERING 100 SW Main Street Suite 1600 Portland, OR 97204 TEL 503.382.2266 FAX 503.382.2262 www.interfaceengineering.com		14410 SE Petrovitsky Rd. Suite 206 Renton, WA 98058 425-291-7078		Approved: Project Director APPROVER		SPOKANE VA MEDICAL CENTER SPOKANE, WASHINGTON 99205		Building Number 40A			
99% CONSTRUCTION DOCUMENT 12/30/14						Location SPOKANE, WASHINGTON 99205		Issue Date 11/02/2015		Checked JRM			Drawing Number PL602 Dwg. of
95% CONSTRUCTION DOCUMENT 10/13/14						65% DESIGN DEVELOPMENT 6/27/14		SCHEMATIC DESIGN 3/28/14		Drawn IEI			
Revisions		ISSUES		Date									

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




1 STORM DRAIN SEWER RISER DIAGRAM
NO SCALE

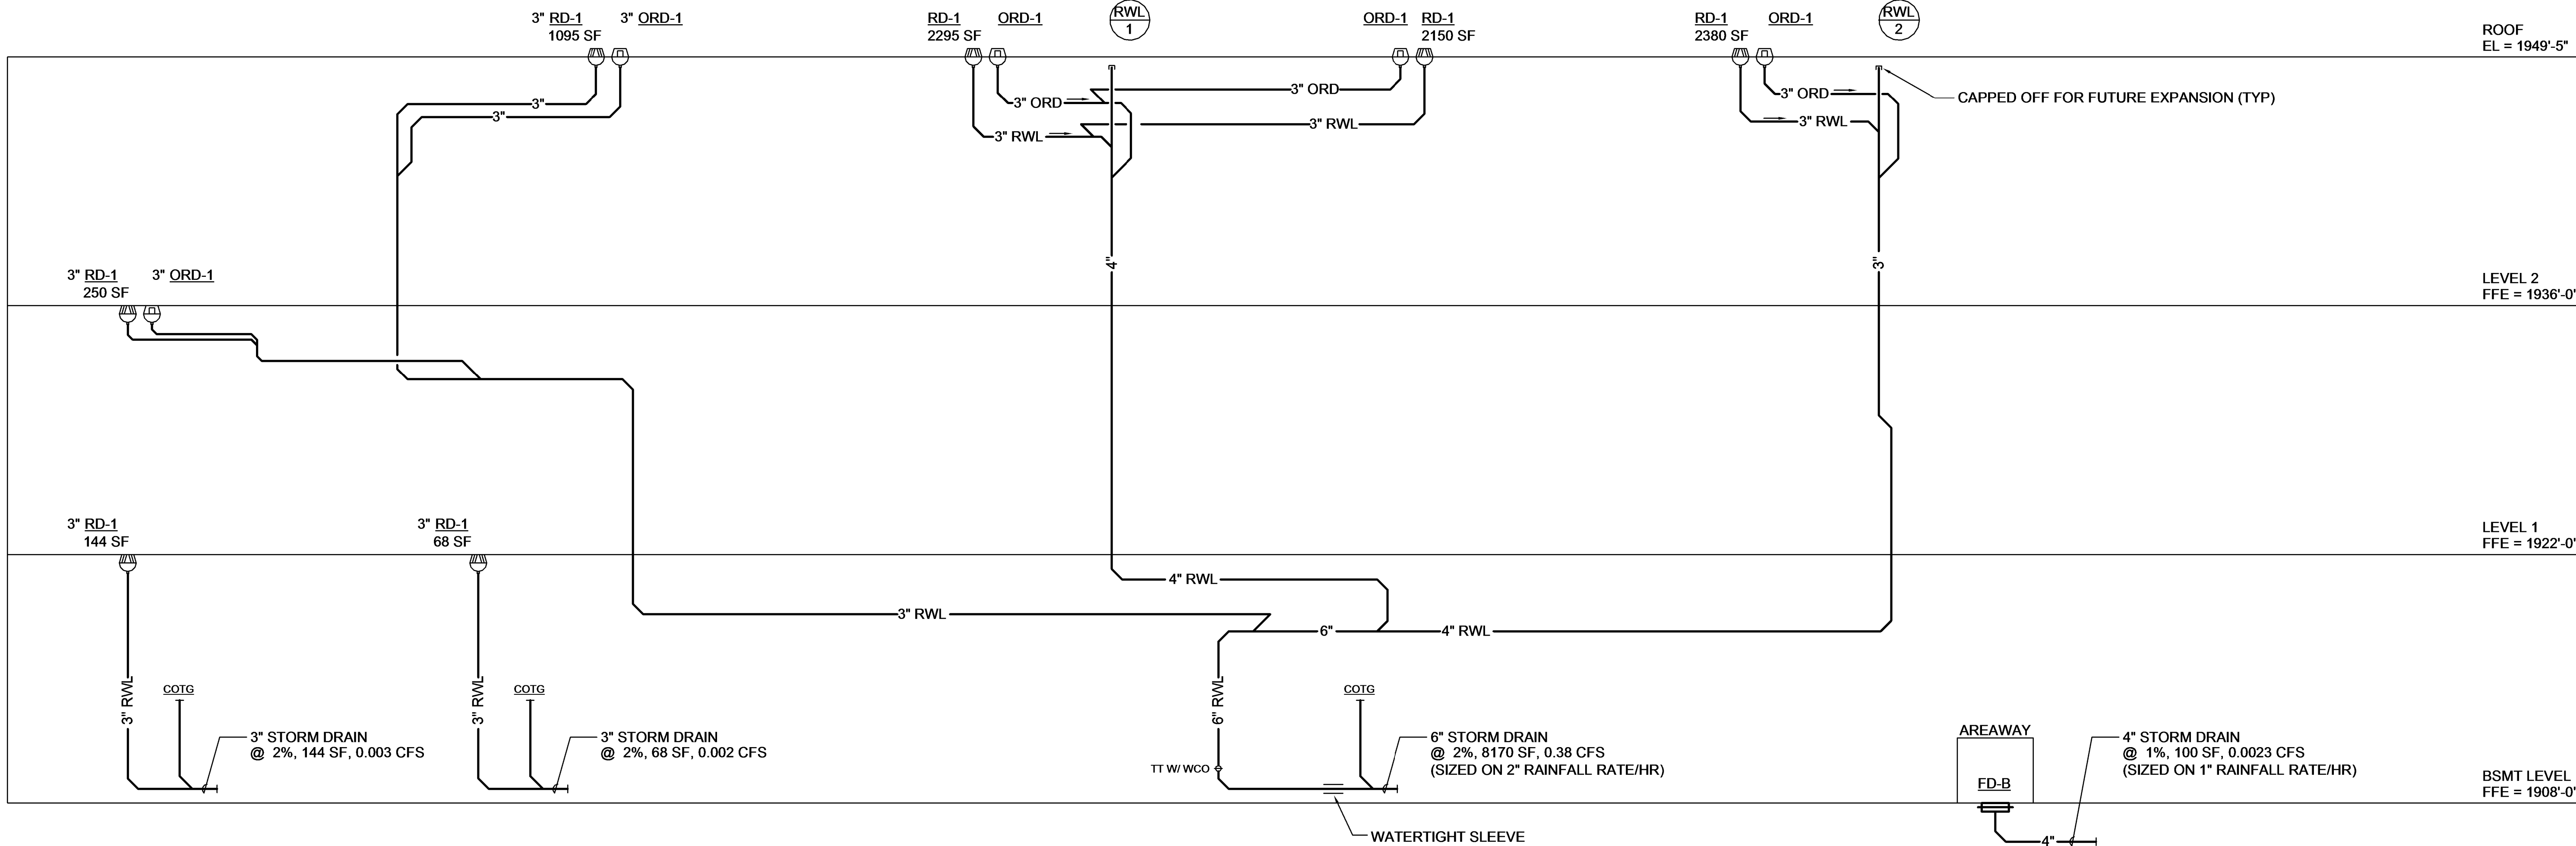GENERAL SHEET NOTES

1. INSULATE ALL HORIZONTAL RWL & ORD LINES. DO NOT INSULATE VERTICAL LEADERS.

BID DOCUMENT
NOVEMBER/02/2015

			CONSULTANTS:		ARCHITECT/ENGINEERS:		Drawing Title		Project Title		Project Number		Office of Construction and Facilities Management	
	BID DOCUMENT	11/02/2015	<div><div>PROJECT 2013-0512 CONTACT John McMichael</div><div>INTERFACE ENGINEERING</div><div>100 SW Main Street Suite 1600 Portland, OR 97204 TEL 503.382.2266 FAX 503.382.2262 www.interfaceengineering.com</div></div>		<div></div> <div>EXP. 4/13/16 11/02/15</div>		14410 SE Petrovitsky Rd. Suite 206 Renton, WA 98058 425-291-7078		PLUMBING RISER DIAGRAMS		INTENSIVE OUTPATIENT MENTAL HEALTH AND EDUCATION BUILDING SPOKANE VA MEDICAL CENTER SPOKANE, WASHINGTON 99205			
	100% CONSTRUCTION DOCUMENT	1/26/2015					<div>KMA ARCHITECTS</div>		Approved: Project Director		Location SPOKANE, WASHINGTON 99205		Building Number 40A	
	99% CONSTRUCTION DOCUMENT	12/30/14							Approver		Drawing Number			
	95% CONSTRUCTION DOCUMENT	12/17/14									PL603			
	95% CONSTRUCTION DOCUMENT	10/13/14									Dwg. of			
	65% DESIGN DEVELOPMENT	6/27/14							Issue Date		Checked		Drawn	
	SCHEMATIC DESIGN	3/28/14			11/02/2015		JRM		IEI					
Revisions	ISSUES	Date											Department of Veterans Affairs	

PLUMBING PUMP SCHEDULE

PLUMBING BACKFLOW PREVENTER SCHEDULE							
				BASIS OF DESIGN			WEIGHT
MARK	DECRPTION	SYSTEM	CAPACITIES	MANUFACTURER	MODEL	DCW	(LBS)
40A-BFP-1	REDUCED PRESSURE ZONE BACKFLOW PREVENTER	DOMESTIC WATER SERVICE	75 GPM @ 15 PSI DROP.	WILKINS	975-U-S-AG	2"	16
40A-BFP-2	REDUCED PRESSURE ZONE BACKFLOW PREVENTER	DOMESTIC WATER SERVICE	75 GPM @ 15 PSI DROP.	WILKINS	975-U-S-AG	2"	16
40A-BFP-3	REDUCED PRESSURE ZONE BACKFLOW PREVENTER	HVAC MAKE-UP WATER	20 GPM @ 15 PSI DROP.	WILKINS	975XL2U-S-AG	3/4"	15
NOTES:							
1	PROVIDE WYE STRAINER WITH THREADED END BALL VALVE WITH CAP & CHAIN ON SUCTION SIDE OF BACKFLOW PREVENTER ASSEMBLY AND UNION TYPE BALL VALVES ON BOTH SIDES OF BACKFLOW PREVENTER ASSEMBLY.						

PLUMBING BACKFLOW PREVENTER SCHEDULE

MARK	DESCRIPTION	SYSTEM	CAPACITIES		BASIS OF DESIGN		DCW	WEIGHT (LBS)
					MANUFACTURER	MODEL		
40A-BFP-1	REDUCED PRESSURE ZONE BACKFLOW PREVENTER	DOMESTIC WATER SERVICE	75 GPM @ 15 PSI DROP.		WILKINS	975-U-S-AG	2"	16
40A-BFP-2	REDUCED PRESSURE ZONE BACKFLOW PREVENTER	DOMESTIC WATER SERVICE	75 GPM @ 15 PSI DROP.		WILKINS	975-U-S-AG	2"	16
40A-BFP-3	REDUCED PRESSURE ZONE BACKFLOW PREVENTER	HVAC MAKE-UP WATER	20 GPM @ 15 PSI DROP.		WILKINS	975XL2U-S-AG	3/4"	15
NOTES: 1	PROVIDE WYE STRAINER WITH THREADED END BALL VALVE WITH CAP & CHAIN ON SUCTION SIDE OF BACKFLOW PREVENTER ASSEMBLY AND UNION TYPE BALL VALVES ON BOTH SIDES OF BACKFLOW PREVENTER ASSEMBLY.							

PLUMBING DEVICES SCHEDULE

MARK		DESCRIPTION	SYSTEM	CAPACITIES	BASIS OF DESIGN		CONNECTION			WEIGHT (LBS)
					MANUFACTURER	MODEL	DCW	DHW	TW	
40A-TP-1		TRAP PRIMER	DOMESTIC COLD WATER		PPP	PR-500 PRIME RITE	1/2"			10
40A-DWM-1		DOMESTIC WATER METER	DOMESTIC COLD WATER	126 GPM PEAK LOAD	NEPTUNE	HP TURBINE METER				
40A-TMV-1		THERMOSTATIC MIXING VALVE - MASTER	DOMESTIC HOT WATER	35 GPM @ 15 PSI DROP. SET AT 125 F	LEONARD	LV-982-LF-RF-BD7	1"	1"	1-1/4"	25
40A-TMV-2		EMERGENCY EYE WASH MIXING VALVE	DOMESTIC HOT WATER	5 GPM @ 15 PSI DROP. SET AT 85 F	LAWLER	911EF	1/2"	1/2"	1/2"	15
40A-TMV-3		THERMOSTATIC MIXING VALVE WITH CHECK MODULES - LAVATORIES	DOMESTIC HOT WATER	1 GPM @ 2 PSI DROP. SET AT 105 F	LAWLER	570	1/2"	1/2"	1/2"	2
40A-PRV-1		PRESSURE REDUCING VALVE STATION	DOMESTIC COLD WATER	80 GPM @ 10 PSI LOSS, 95 PSI STATIC, SET UNIT @ 65 PSI DISCHARGE	WILKINS	500XLHTSTSC	2"			10
40A-PRV-2		PRESSURE REDUCING VALVE STATION	DOMESTIC COLD WATER	40 GPM @ 10 PSI LOSS, 95 PSI STATIC, SET UNIT @ 76 PSI DISCHARGE	WILKINS	500XLHTSTSC	1-1/4"			5

PLUMBING ELECTRICAL DEVICES SCHEDULE

MARK	DESCRIPTION	SYSTEM	BASIS OF DESIGN		CAPACITIES	ELECTRICAL				WEIGHT (LBS)
			MANUFACTURER	MODEL		VOLTS	PH	AMPS	HZ	
EW-C-1	ELECTRIC WATER COOLER	PLUMBING FIXTURE	SEE PLUMBING FIXTURE SPECIFICATION	SEE PLUMBING FIXTURE SPECIFICATION	8 GPH OF 50 F CHILLED WATER	120	1	5	60	175
P-101, P-101A, P-201 & P-202	ELECTRIC FLUSH VALVES	PLUMBING FIXTURE	SEE PLUMBING FIXTURE SPECIFICATION	SEE PLUMBING FIXTURE SPECIFICATION	1 TRANSFORMER PER 2 FLUSH VALVES	24	1			5
S-532	SINK	HW DISPENSER	SEE PLUMBING FIXTURE SPECIFICATION	SEE PLUMBING FIXTURE SPECIFICATION		120	1	6.25	60	15
40A-A-1	AQUASTAT	DOMESTIC WATER HEATING SYSTEM	HONEYWELL	L6006C1018	65 TO 200 F, SET AT 118 F	120	1	8	60	5
40A-HT-1	HEAT MAINTENANCE TAPE	ROOF DRAIN SYSTEM	RAYCHEM	ICE-STOP	30 FEET OF CABLE, 12W/FT2	120	1		60	15
NOTES: 1	COORDINATE EXACT LOCATION AND ELEVATION OF ELECTRICAL DEVICE WITH DIVISION 26 WORK.									

DOMESTIC WATER SERVICE CALCULATIONS

FIXTURE QUANTITY	DESCRIPTION	UNIT FIXTURE			TOTAL FIXTURE UNITS		
		DWS WSFU	DCW CWFU	DHW HWFU	DWS WSFU	COLD CWFU	HOT HWFU
17	WATER CLOSET, FV, 1.28 GPF	10.00	10.00		170.00	170.00	
7	URINAL_FV, 0.125 GPF	5.00	5.00		35.00	35.00	
15	LAVATORY/HANDSINKS	1.00	0.75	0.75	15.00	11.25	11.25
10	SINK	2.00	1.50	1.50	20.00	15.00	15.00
1	SINK - STAFF	2.00	1.50	1.50	2.00	1.50	1.50
4	SERVICE SINK OR MOP BASIN (COUNT 1)	3.00	2.25	2.25	3.00	2.25	2.25
7	DRINKING FOUNTAIN OR WATER COOLER	0.50	0.50		3.50	3.50	
1	EMERGENCY EYE WASH	5.00	3.75	3.75	5.00	3.75	3.75
10	HOSE BIBB/WALL HYDRANTS	2.50	2.50		25.00	25.00	
1	HVAC MAKE-UP	20.00	20.00		20.00	20.00	
1	IRRIGATION MAKE-UP	20.00	20.00		20.00	20.00	
1	EXISTING BLDG 40E	180.00	180.00		180.00	180.00	45.00
				TOTAL FLOW:GPM	499 137	487 136	79 38
				MAIN SIZE	4"	3"	1-1/2"

SANITARY SEWER DWV CALCULATIONS

QTY	DESCRIPTION	GENERAL	TOTAL FIXTURE UNITS
17	WATER CLOSET, 1.128 GPF FLUSHOMETER VALVE	6.00	102.00
5	URINALS, 0.125 GPF FLUSH VALVE	2.00	10.00
15	LAVATORY/HAND SINKS	1.00	15.00
10	SINK, CRS	3.00	30.00
1	SINK, STAFF	3.00	3.00
4	SERVICE SINK OR MOP BASIN, 3" TRAP	3.00	12.00
6	DUAL UNIT BARRIER FREE ELECTRIC WATER COOLER	0.50	3.00
16	FINISHED AREA FLOOR DRAIN A - 2"	2.00	32.00
4	UNFINISHED AREA/MECH RM FLOOR DRAIN B - 4"	6.00	24.00
2	HUB DRAIN - 6"	6.00	12.00
		TOTAL PIPE SIZE CFS	243.00 6" 22.00

PLUMBING FIXTURE SCHEDULE

[illegible]

PLUMBING SHOCK ARRESTOR SCHEDULE

		CONNECTION		REMARKS
SYMBOL	DESCRIPTION	SIZE	FIXTURE UNITS	
SA-A	SHOCK ARRESTOR	1/2"	1 - 11	
SA-B	SHOCK ARRESTOR	3/4"	12 - 32	
SA-C	SHOCK ARRESTOR	1"	33 - 60	
SA-D	SHOCK ARRESTOR	1-1/4"	60 - 113	
NOTES:				
1	PROVIDE SHOCK ARRESTORS AT THE LOCATIONS OF WATER CLOSETS, HEATERS URINALS, HOSE BIBBS, WALL HYDRANTS, EWC'S, ELECTRONIC DEVICES, PVI ASSEMBLIES & LOCATIONS SHOWN ON SHEET PL801			
2	PROVIDE ACCESS PANEL AT EACH LOCATION.			
3	WHEN BRANCH LINE PRESSURE EXCEEDS 65 PSI PROVIDE NEXT LARGER SIZE ARRESTOR.			

BID DOCUMENT
NOVEMBER/02/2015

[illegible]